




ATTACHMENTS

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7.2	PA2022220 - Development of an Extension to a Building used for Industry, a Reduction of Car Parking (Nine Car Spaces) and a Waiver of Bicycle Facilities at Lot 1 on PS619842Y known as 53 Haddon Drive, Ballan	:
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7.3	PA2022243 - Use and Development of a Dwelling and Ancillary Shed at Crown Allotment Section 5 of TP293871, 177 Corries Lane Mount Egerton	3,
	Attachment 1 Plans	6
7.4	PA2022096 - Two Lot Subdivision at 190 Lerderderg Gorge Road, Darley	
	Attachment 1 Proposed Plan of Subdivision	14

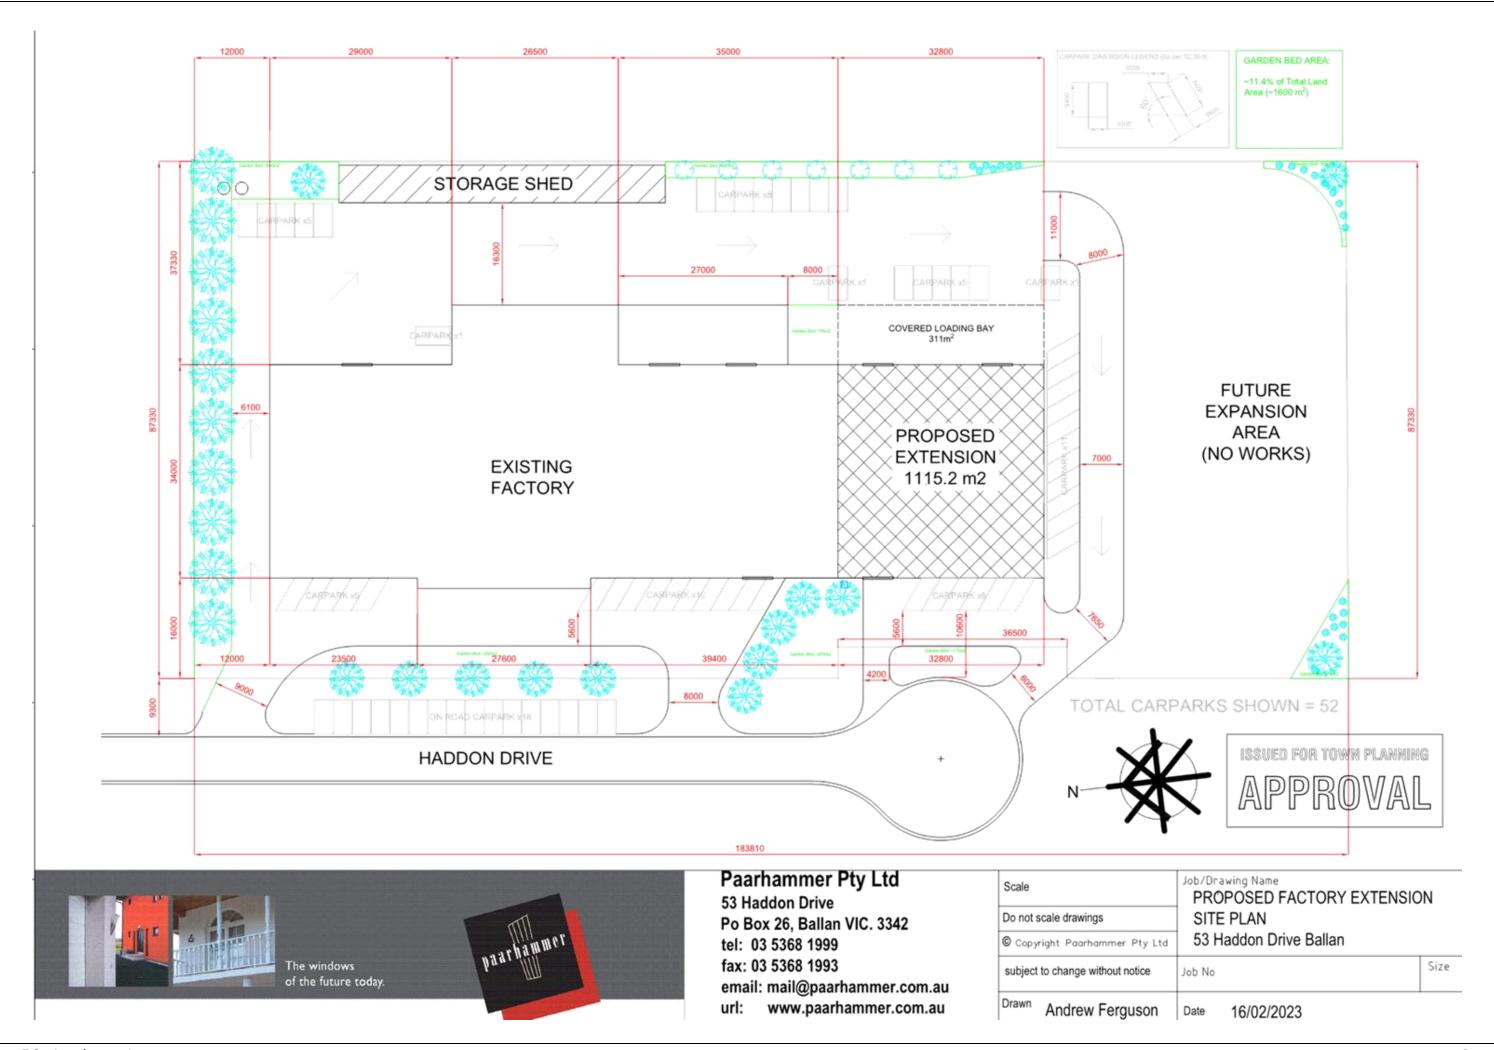

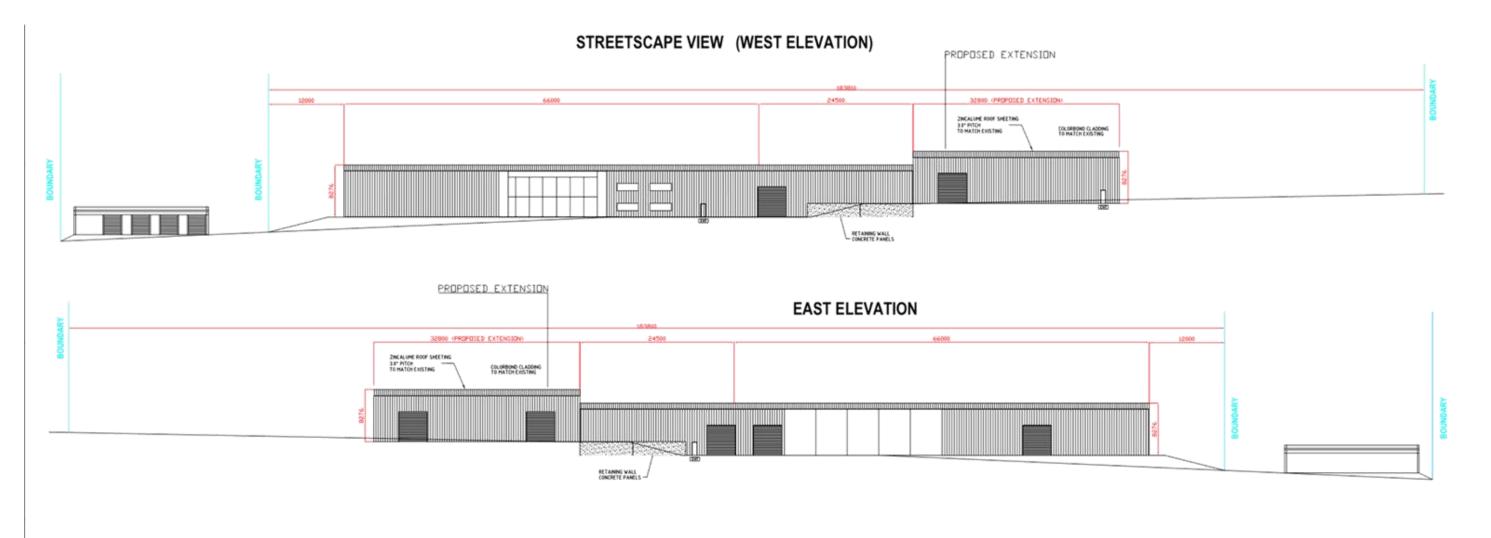



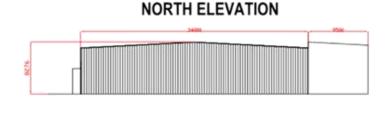54.03-3



MUNICIPAL PLANNING SCHEME

33.01.1	THE SITE IS LOCATED ON INDUSTRIAL 2 ZONE THE THRESHOLD DISTANCE IS
	GREATER THAN 100M (693.4m) TO THE NEAREST RESIDENTIAL ZONE. THE PROPERTY
	IS ON THE BOUNDARY OF INDUSTRIAL ZONE 2 AND FARMING ZONE

54.02-1 NEIGHBORHOOD CHARTER OBJECTIVE
TO ENSURE THAT THE DESIGN RESPECTS THE EXISTING NEIGHBORHOOD CHARACTER

54.02-2 NEIGHBORHOOD CHARACTER OBJECTIVE
INTEGRATE THE LAYOUT OF THE DEVELOPMENT WITHIN THE STREET

54.03-2	NEIGHBORHOOD HEIGHT OBJECTIVE
	TO ENSURE THAT THE HEIGHT OF BUILDINGS RESPECTS THE EXISTING OR PREFERED
	NEIGHBORHOOD CHARACTER

IF NO MAXIMUM HEIGHT IS SPECIFIED IN THE ZONE THE MAXIMUM BEULDING HEIGHT SHOULD NOT EXCEED 9.0m

CHANGES IN BUILDING HEIGHT BETWEEN EXISTING BUILDINGS AND NEW SHOULD BE GRADUATED





Paarhammer Pty Ltd

53 Haddon Drive

Po Box 26, Ballan VIC. 3342

tel: 03 5368 1999 fax: 03 5368 1993

email: mail@paarhammer.com.au url: www.paarhammer.com.au

	Scale	Job/Drawing Name PROPOSED FACTORY EXTENSION		
Do not scale drawings		ELEVATIONS		
© Copyright Paarhammer Pty Ltd		53 Haddon Drive Ballan		
subject to change without notice		Job No	Size	
	Drawn Andrew Ferguson	Date 01/02/2023		

Item 7.2 - Attachment 1 Page 5

BAL-12.

Planning grawings

GENERAL NOTES

-All materials and work practices shall comply with, but not limited to the Building Regulations 2018.

National Construction Code series 2019 Building Code of Australia Vol.2 and all relevant current Australian Standards (as amended) referred to herein

-Unless otherwise specified, the term BCA shall refer to the National Construction Code Series 2019 Building Code of

-All materials and construction practice shall meet the Performance Requirements of the BCA. Where a performance solution is proposed then, prior to implementation or installation, it first must be assessed and approved by the Relevant Building Surveyor (forewith referred to as RBS) as meeting the requirements of the Performance Requirements

-Glazing, including safety glazing shall be installed to a size, type and thickness so as to comply with: BCA Part 3.6 for Class 1and 10 buildings within a design wind speed of not more than N3; and

BCA Vol 1 Part B1.4 for Class 2 and 9 buildings.

-Waterproofing of wet areas, being bathrooms, showers, shower rooms, laundries, sanitary compartments and the like shall be provided in accordance with AS 3740-2010: Waterproofing of Domestic Wet Areas.

-These drawings shall be read in conjunction with any House Energfy Rating Report (HERS) and shall be constructed in accordance with the stamped plans endorsed by the accredited Thermal Performance Assessor without alteration

-Step sizes (other than for spiral stairs) to be: Risers (R) 190mm max. and 115mm min. - Going (G) 355mm max. and 240mm min. 2R + 1G = 700mm max. and 550mm min. with less than 125mm between treads.

-All treads, landings and the like to have a slip resistance classification of P3 or R10 for dry surface conditions and P4 or R11 for wet surface conditions, or a nosing strip with a slip-resistance classification of P3 for dry surface conditions and P4 for wet surface conditions.

 Provide barriers where change in level exceeds 1000mm above the surface beneath landings, ramps and/or treads. Barriers (other than tensioned wire barriers) to be:

1000mm above finished surface level of balconies, landings and the like, and

865mm minimum above finished surface level of stair nosing or ramp, and

vertical with less than 125mm gap between, and

and horizontal element within the barrier between 150mm and 760mm above the floor must not facilitate climbing where changes in level exceeds 4000mm above the surface beneath landings, ramps and/ or treads

Wire barrier construction to comply with NCC 2019 BCA Part 3.9.2.3 for Class 1 and 10 buildings and NCC 2019 BCA Vol.1 Part D2,16 for other Classes of Buildings.

Top of handrails to be minimum of 856mm vertically above stair nosing and floor surface of ramps.

-Window sizes nominated are nominal only. Actual size may vary according to manufacturer. Windows to be flashed all round. -Where the building (excluding detached Class 10) is located in a termite prone area, the building is to be provided with a termite management system.

Concrete stumps:

up to 1400mm long to be 100mm x 100mm (1 No.HD wire). 1401mm-1800mm long to be 100mm x 100mm (2 No. HD wires). 1800mm - 3000mm long to be 125mm x 125mm (2 No.HD wires). 100mm x 100mm stumps exceeding 1200mm

above ground level to be braced where no perimter base brickwork is provided. -Buildings in marine or other exposure environments shall have masonary units, mortar and all built in components and the like complying with the durability requirements of Table 4.1 of AS 4773.1 - 2010 'Masonary in small buildings' Part 1: Design

-All stormwater to be taken to the legal point of discharge to the Relevant Authorities approval.

-These drawings shall be read in conjunction with all relelvant structural and all other consultant's drawings/ details and with any other written instructions issued in the course of the contract.

-Site plan measurements in metres(m) - all other measurements are in millimetres(mm).

-Figured dimensions take precedence over scaled dimensions.

-The Builder or Sub-contractors shall check and verify all dimensions, setbacks, levels and specifications and all other relevant documentation prior to the commencement of any works. Report all discrepancies to this office for clarification -Installation of all services shall comply with the respective supply authority requirements.

-The Builder and Sub-contractor shall ensure that all stornwater drains, sewer pipes and the like are located at a sufficient distance from any buildings footings and/ or slab edge beams so as to prevent general moisture penetration, dampness weakening and undermining of any building and its footing system.

-These plans have been prepared for the exclusive use by the client of Lee B De Jong Residential Design & Planning ('The Designer') for the purpose expressly notified to the Designer. Any person who uses or relies on these plans without the Designers written consent does so at their own risk and no responsibilty is accepted by the Designer for such use and/ or

-A Building Permit is required prior to the commencement of these works. The release of these documents is conditional to the Owner obtaining the required Building Permit.

-The Client and/ or the Client's Builder shall not modify or amend the plans without the knowledge and consent of Lee B De Jong Residential Design & Planning except where a Registered Building Surveyor makes minor necessary changes to facilitate the Building Permit application and that such changes are promptly reported back to Lee B De Jong Residential Design & Planning

-The arrpoval by this office of a substitute material, work practice, variation or the like is not an authorisation for its use or a Contract variation. All variations must be accepted by all parties to the agreement and where applicable the Relevant Building Surveyor prior to implementing any variation.

-Stormwater drains to be Class 6 UPVC stormwater drains laid to a minimum grade of 1:100 and connected to the legal point of discharge. Provide inspection openings at 9000mm centres and at each change of direction.

Cover to underground stormwater shall not be less than - 100mm under soil. 50mm under paved or concrete areas.

100mm under unreinforced concrete or paved driveways. 75mm under reinforced concrete driveways. -Site classification to be as per Engineers Soil Report referred to in these drawings.

-Design Wind Gust Speed or Wind Calssification to have Building tie-downs in accordance with AS1684-2010 for an assumed design gust wind speed/ wind classification referred to in these drawings.

Climate Zone to be as per that nominated within the Thermal Energy Assessment

 Corrosion protection of built-in structural steel members such as lintels, shelf angles, connectors, accessories (other than wall ties) to be strictly in accordance with Table 4.1 of AS 4773.1 - 2010 Masonary in Small Buildings Part 1: Design. Corrosion Protection for sheet roofing to be in accordance with BCA Table 3.5.1.1a.

SITE PREPARATION

-Builder to be responsible for the shutting off of all existing services prior to commencement of work where required with alteration work and re-connection at the completion or as required and stipulated within the Project Specifications.

-Where nominated on these drawings that fill is required, the Builder to ensure that such fill is clean and free of organic matter and other debris, and where compaction is rerquired, to be carried out in accordance with these drawings or as nominated by the relevant Engineer footing or site preparation design

-The Owner is to verify and be responsible for all title boundaries as documented on the relevant title document.

-The Builder shall clear the site of all top soil, debris and organic matter to the immediate construction area.

CONCRETE

-Unless otherwise noted on these drawings or on accompanying Engineering documentation and design, all structural concrete is to be a minimum 20mpa and to have a nominal slump of 100mm.

 Concrete for footings and footings genrally to be in accordance with A.S.2870-2011 unless otherwise nominated on the Engineers Design.

-All footings to be founded down to a soil of suitable bearing capacity as nominated as a minimum in the soil test and footing design, and all trenches, footings and reinforcement to meet the minimum requirements of such design.

-Engineering footing design overrides any corresponding footing detail descrepency nominated on these drawings. Control joints to be in accordance with A.S.3600 unless otherwise nominated in Engineers Design. -All aggregates used in any concrete on this project to be

clean and free of dust and all organic matters and to be dry at time of mixing.

BRICKWORK & MASONARY

-Unless otherwise noted on these drawings or In accompanying sspecification, brickwork shall be laid as Stretcher Bond and in accordance with current best practices.

-Damp proof courses, flashings, brick ties, weepholes and sub-floor ventillation to be supplied and installed as per the Building Code of Australia Regulations (BCA) or the National Construction Code (NCC).

 Articulation of brickwork to be as nominated on these drawings or as per Engineers Design. Joints to be continuous from base of wall to top.

-All aggregates used in any mortar on this project to be clean and free of dust and all organic matters and to be dry at the time of mixing.

CARPENTRY AND JOINERY

-All timber framing to be strictly in accordance with A.S.1684 and as per the requirements of the BCA and

-All pre-fabricated structural timber elements shall be installed as per the manufacturers specifications including and bracing, tie downs and other accessories. -Unless otherwise noted within these drawings, all eaves

barges and soffits shall be lined with 4.5mm thick fibre cement sheet. -Timber framing to box gutters will be set up to provide suitable fall of a minimum of 1:100 to nominated outlets.

 Ceiling access point must be installed to all ceiling cavity spaces where access is possible. -All claddings, timber or other to be suitably protected from weathering and in the case of alternate claddings, proprietory cappings and recommended installation are

to be adopted in full. External timbers, such as for stairs, to be of suitable species and treatments for the conditions for which it is to be exposed.

-Where structural timbers are to be exposed externally, they shall be suitable coated, primed or treated to adequately perform without rotting or deterioration.

-Joinery generally, where not indicated on these drawings shall be determined by the Specifications and or through consultation between Joiner and Builder.

 Locks and door furniture to be strictly as per the minimums within the NCC and shall be as per the Specifications. -Where steel framing for walls and or trusses, the details and installation shall be as per manufactures specifications. -Lift off door hinges to be provided where 1200mm clearance from door swing to sanitary pan cannot be

ENERGY PROVISIONS

-The energy provisions required under the NCC for residential commercial or industrial structures shall be as per these drawings in conjunction with HERS FirstRate5 software Certificate and or Deemed to Satisfy and other supporting documentation.

Standards and levels of insulation may not be reduced in any manner without consultation with this office whereby an amended certificate may be required to be issued by this office. Builder is to ensure that all adequate measures are undertaken to reduce the build up of condensation with the use of breathable or anti-condensation wraps. Where adequate vetillation cannot be acheived, suitable natural or mechanical air extraction may required. No such device indicated on these drawings is to be removed without prior consultation with this office.

 Builder or installer of insulation is to ensure that no uneccessary compression of batts occurs during installation and that foils and wraps are pulled tightly to avoid creasing and folding. To eaves, Builder to ensure that eave batts are utilized and that insulation installed does not block paths of ventillation

-All external dooors and windows to be sealed and weatherstripped Insulation installer or Builder to ensure that adequate clearance exists to exhaust fans and lighting fittings.

-Claddings and materials are to be as nominated on these drawings

-Drainage to roofing to be strictly in accordance with A.S.3500

 -Upon completion of iron roofing the Builder shall sweep down and remove any metal shavings or debris from the roof or guttering

WATER SUPPLY

 The Owner is responsible for the provision of a private water tap to the front of the property unless otherwise nominated in the Specifications.

-Hot Water Service to be installed as per these drawings and are to be strictly in accordance with regulatory water saving measures. Septic Tank, where required, shall be installed as per the approved requirements of the Local Health Authority

SEWER & DRAINAGE

-All sewer drainage to be carried out as per the Local Authority requirements.

-Sealed stormwater systems to be 100mm dia PVC to discharge into rainwater tanks with overflow to legal point of discharge. Minimum fall of 1:100 to be provided.

-Where cutting of soils occurs, the base of all cuts are to have a spoon an agricultural drain connecting to silt pits and attached to stormwater system. -Septic Tank, where required, shall be installed as per the

approved requirements of the Local Health Authority

SHEET DETAIL:

FL FCTRICAL

exceeded.

-Electrical layout to be as per that contained on these drawings as with electrical loadings nominated and as per the Energy Provisions of the BCA. Where alterations are made to the accompanying layout, the Builder and Electrician are to ensure that the maximum loads are not

 Where no layout is provided the maximums contained in BCA shall apply.

-Smoke detectors to be fully interconnected, and to be installed and located strictly in accordance with A.S.3786

PLASTERING & INTERNAL LININGS

-Unless notes otherwise on these drawings, all internal linings are to be 10mm thick plasterboard. Ceilings to be generally fixed to 22mm steel ceiling battens. -Wet areas to be tiled or lined with water impervious

surface material as per A.S.3740 and in accordance with NCC 3.8.1. Shower bases to be polymarble or similar unless noted otherwise as cast-in-situ. Cast-in showers are to be suitably sealed with approved sealing systems installed strictly to manufacturers specification.

GLAZING AND WINDOWS

-All glazing to comply to A.S.1288 - Glass in Buildings. -Windows nominated in these drawings and referenced in the energy report to be supplied as units with maximum 'U' Values and should not deviate more than 10% of the 'SHGC value attributed to such unit. Substitution of any window units must still comply to the given values in the report.

-Grade A 4mm thick safety glazing to be used in wet areas as per BCA.

 -Variations to glazing standards applies to areas deemed to be in a bushfire zone. BAL Construction notes found on these drawings (where applicable) will stipulate the required increase in glazing thickness or type. -Openings to higher or upper storey sashes to have limited

functioning for fall protection as per the NCC and BCA.

-All external surfaces to be painted to be suitably cleaned and primed in preparation for painting in accordance with the paint manufacturers recommendations and coats also applied accordingly as a minimum of two. All external surfaces to be stained or clear coated to be suitably cleaned and prepared in accordance with the application suppliers recommendations and coats as such. -Where dark coloured paints with a Light Reflective Value (LRV) of less than 40% are to be applied, applicable additives to be introduced into the paint to reduce heat absorption of the paint.

CONDENSATION MANAGEMENT

-Pliable building membaranes to comply and be installed as per A.S.4200.1 & 2 and to be vapour permeable in climate zones 6,7 & 8

-Exhaust fans to be discharged via duct or shaft externally or to a suitably ventilated roof space in accordance with NCC

-Exhaust fans to Kitchens and Laundries to have a flow rate of 40L/s and 25L/s to other sanitary compartments

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03 5334 3463 0414 759 755

Ideiong39@gmail.com

1 Ningana Street, Alfredton, VIC 3350

trered Building Practitioner DP-AD1792 Certified Energy Rater BDAV Member


PROPOSED NEW RESIDENCE AT 177 CORRIES LN, MOUNT EGERTON FOR J. SHERMAN & R. SHERMAN

DRWG No. SCALES: 27-04-2022 Ρ N/A 22023 DRAWN: WIND: SHEET No 1 OF 8 N2 LD


14A Neerim Cres. Mitchell Park, Vic. 3352. Ph. 03 5334 5054 Mob. 0419 106 901

GENERAL NOTES [∿]A3 AMENDMENT: AREAS Planning further info request. Alterations to Management plan layout Ground Floor: 244.21m2 First Floor: Garage: 39.24m2 27.56m2 Alfresco 14.37m2 Paving(rear inc Alf):66.01m2 TOTAL 325.38m2 or 35.02sqs

Item 7.3 - Attachment 1

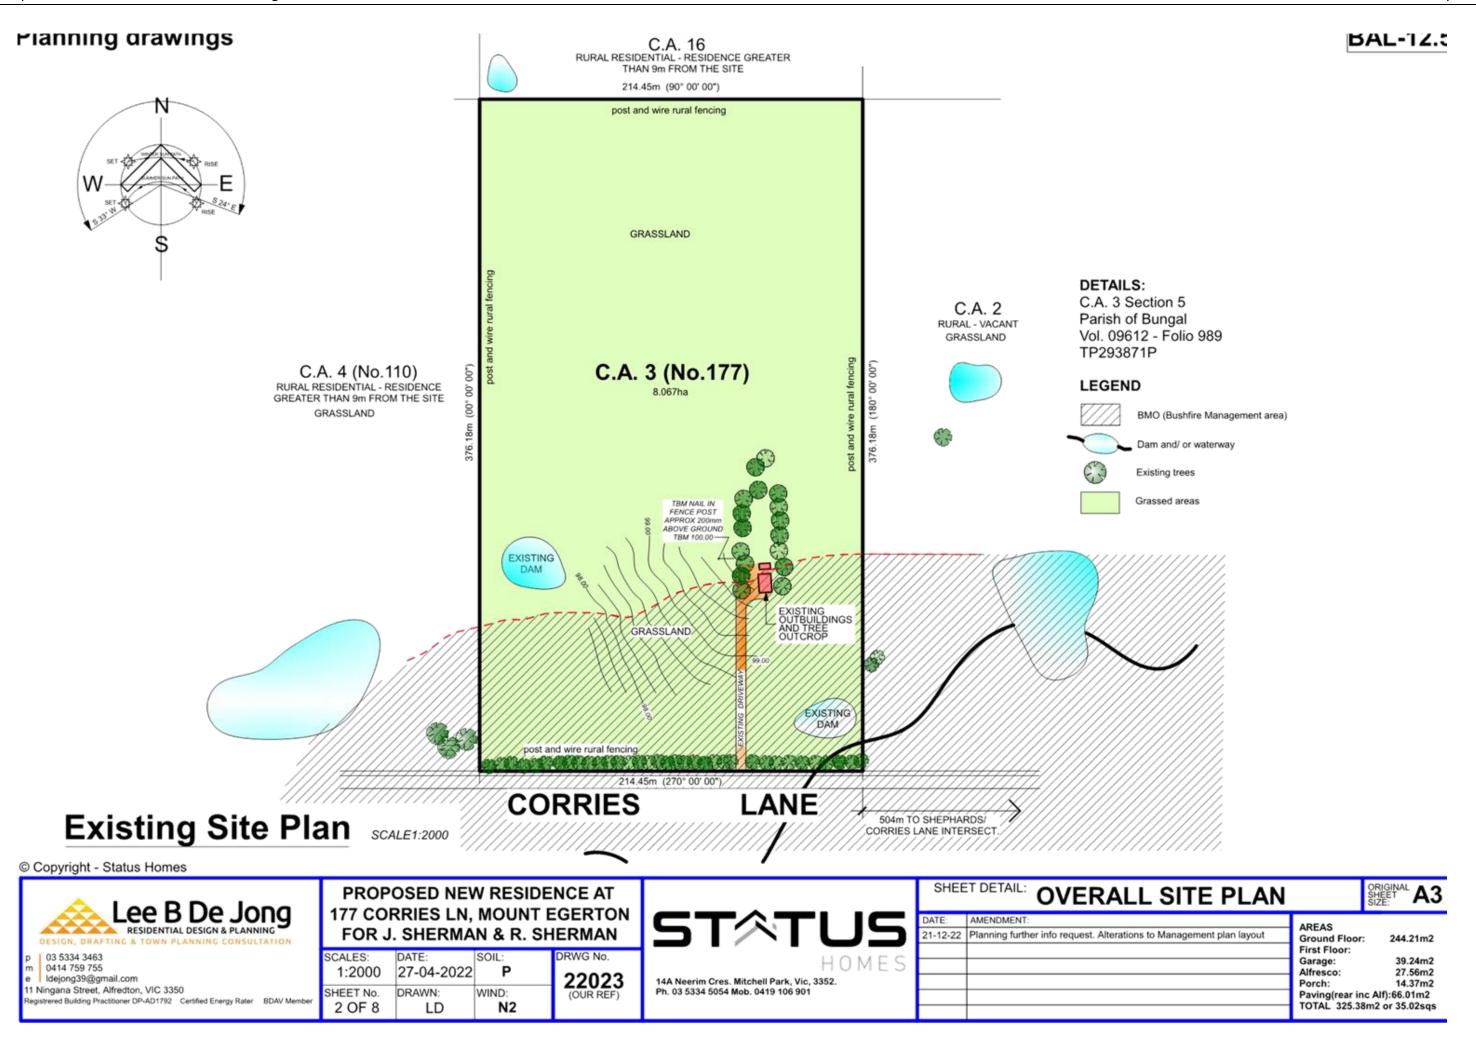

Planning grawings BAL-12. C.A. 16 RURAL RESIDENTIAL - RESIDENCE GREATER THAN 9m FROM THE SITE 214.45m (90° 00' 00") post and wire rural fencing ROTATING SAFRON 1.1 SAFRON C.A. 3 (No.177) 91.00m 1.1 C.A. 2 1.1 RURAL - VACANT Waste water LAA GRASSLAND ROTATING Planting Native tree belt including: Yellow Gum, Black Wattle, Silver SAFRON C.A. 4 (No.110) Wattle, Manna Gum & Candlebark RURAL RESIDENTIAL - RESIDENCE GREATER THAN 9m FROM THE SITE BMO (Bushfire Management area) GRASSLAND Dam and/ or waterway post and wire rural fencing Existing trees GRAZING BIODIVERSITY ROTATING PADDOCK 2 SAFRON CROP PROPOSED RESIDENCE **PROPOSED** FL 99.35 SHED STOCK HOLDING PADDOCK post and wire rural tencing GRAZING PADDOCK 1 Proposed Site Plan SCALE 1:2000 504m TO SHEPHARDS/ © Copyright - Status Homes ORIGINAL A3 **PROPOSED SITE PLAN** PROPOSED NEW RESIDENCE AT Lee B De Jong 177 CORRIES LN, MOUNT EGERTON AMENDMENT: AREAS FOR J. SHERMAN & R. SHERMAN Ground Floor: 244.21m2 First Floor: 03 5334 3463 SCALES: DRWG No. Garage: 39.24m2 0414 759 755 1:2000 27-04-2022 Alfresco: 27.56m2 22023 ldejong39@gmail.com 14A Neerim Cres. Mitchell Park, Vic. 3352. 14.37m2 1 Ningana Street, Alfredton, VIC 3350 SHEET No. DRAWN: WIND: Paving(rear inc Alf):66.01m2 rered Building Practitioner DP-AD1792 Certified Energy Rater BDAV Member 3 OF 8 LD N2 TOTAL 325.38m2 or 35.02sqs

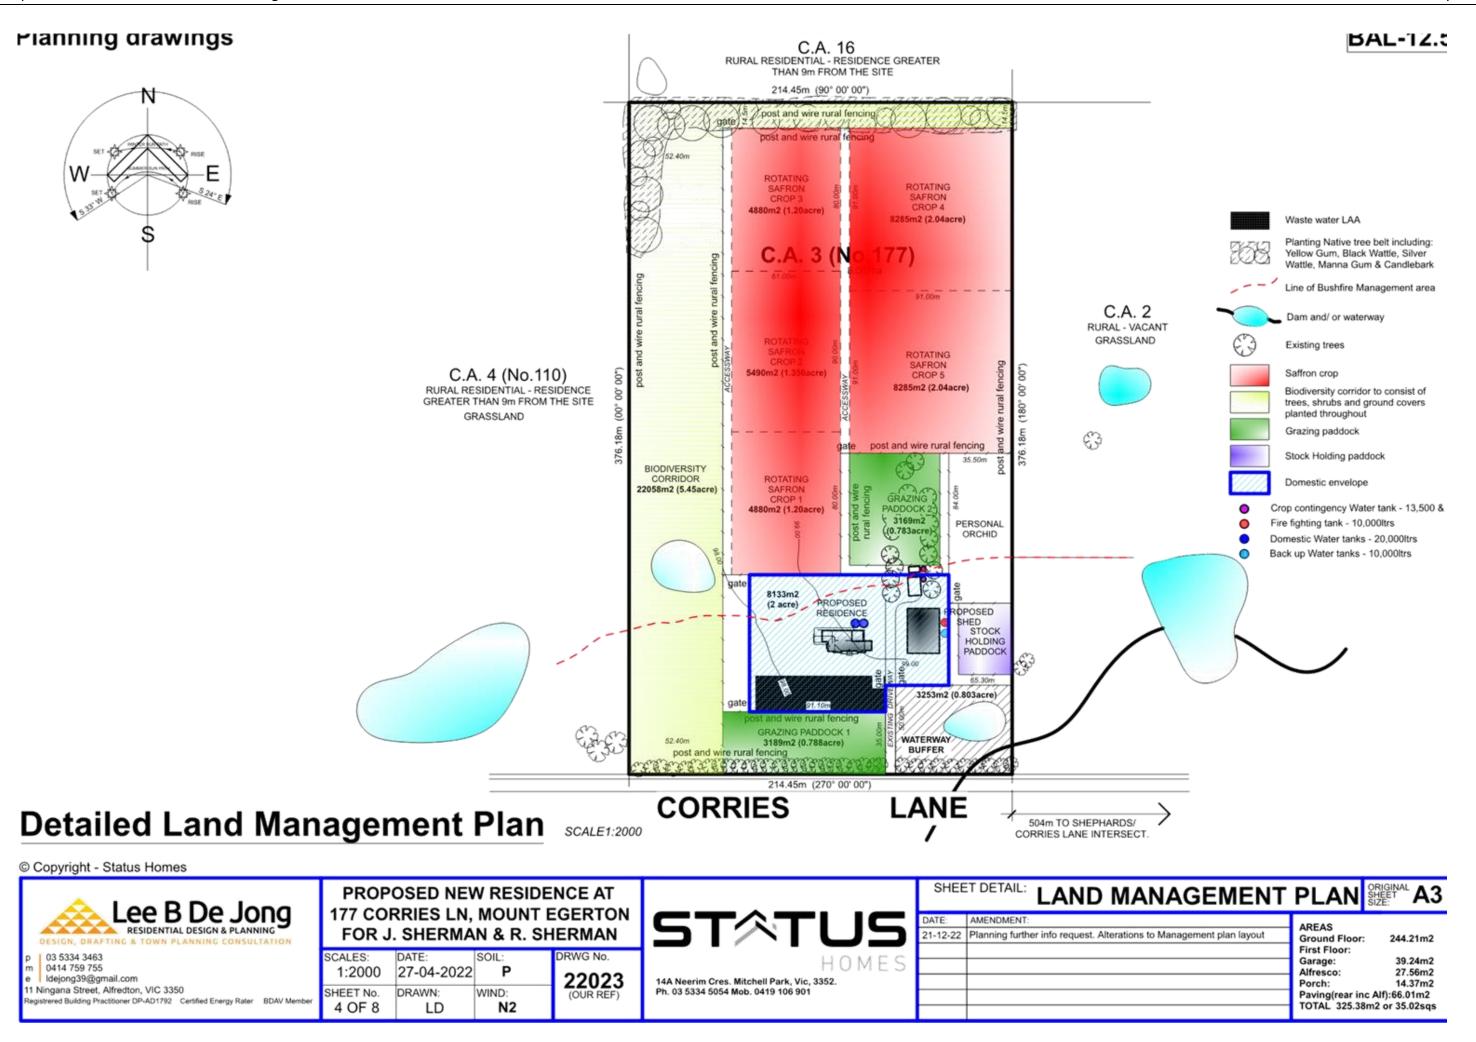


DIAL BEFORE YOU DIG

Australia & National Referral Service for Information on Underground Pipes & Cables

DIAL BEFORE YOU DIG

BAL-12.

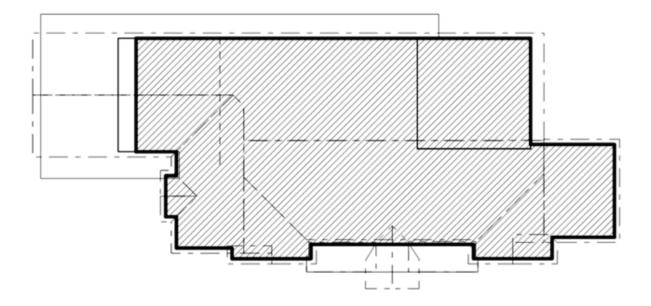


Site Plan SCALE1:200

F.F.L. TO BE CONFIRMED ON SITE BY BUILDING SUPERVISOR AFTER THE COMPLETION OF SITE WORKS. SITE SCRAPE ONLY TO 100.25

DOWNPIPES TO CONNECT TO 100mm DIA SEALED PVC STORMWATER DRAINS WHERE SHOWN AND TO DISCHARGE INTO THE RAINWATER TANK. TANK OVERFLOW TO DISCHARGE INTO L.P.O.D. MIN. FALL 1:100. RAINWATER TANK TO HAVE 2000LTR SET ASIDE ALLOCATION FOR SANITARY FLUSHING PURPOSES

REFER CONTRACTS AND SPECIFICATIONS AS TO THE EXTENT OF FENCING ALLOWANCE

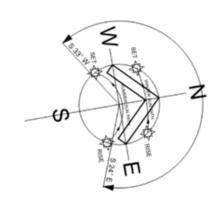

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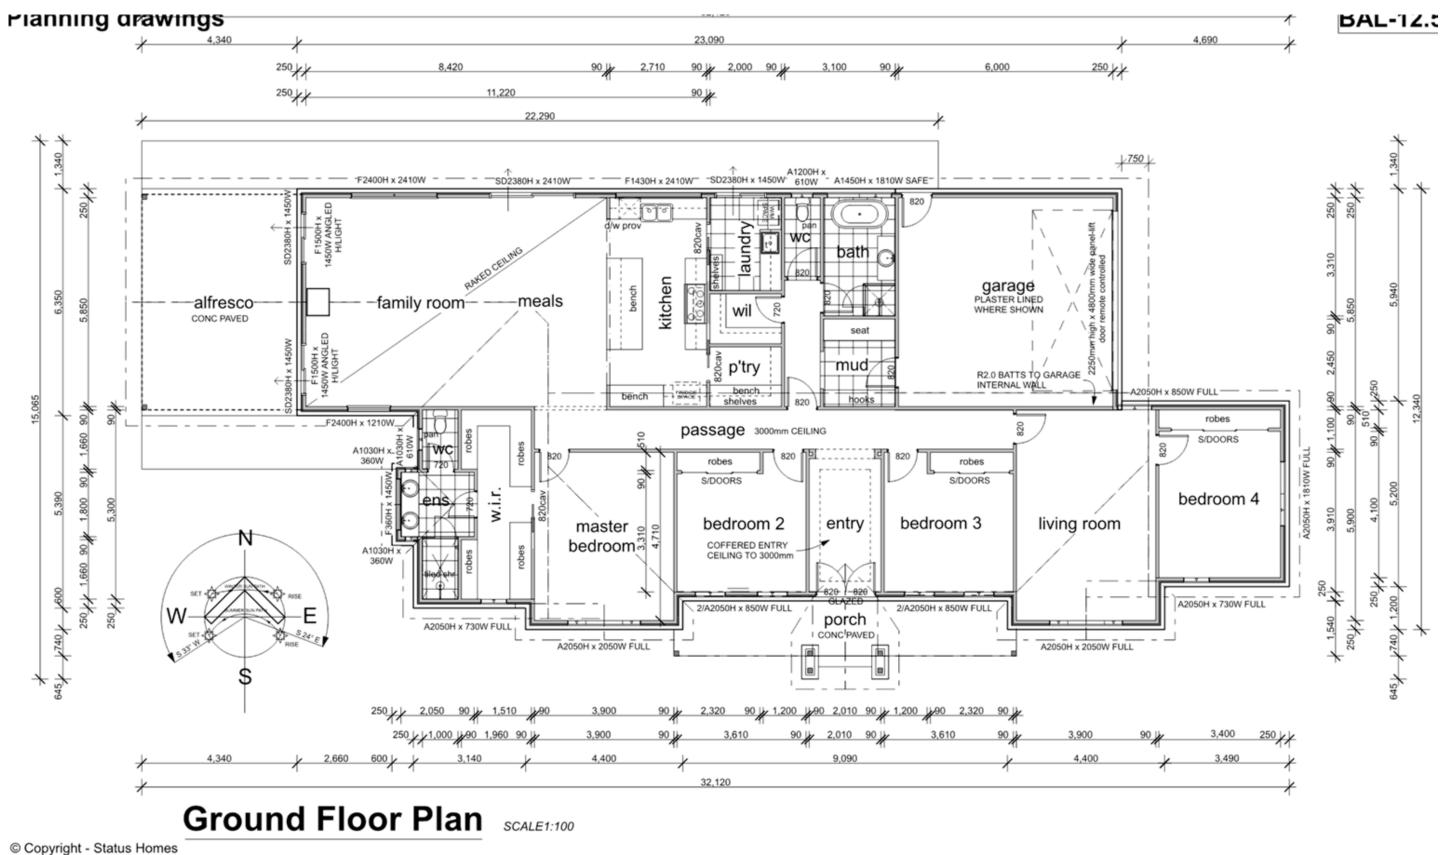


TOR J. SHERWAN & R. SHERWAN			
CALES:	DATE:		DRWG No.
1:200	27-04-2022	P	2202
HEET No.	DRAWN:	WIND:	(OUR REF
5 OF 8	LD	N2	

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HOMES
14A Neerim Cres. Mitchell Park, Vic, 3352. Ph. 03 5334 5054 Mob. 0419 106 901

SHE	SITE PLAN		ORIGINAL A3 SHEET A3
DATE:	AMENDMENT:	AREAS	
21-12-22	Planning further info request. Alterations to Management plan layout	Ground Floor:	244.21m2
		Garage: Alfresco:	39.24m2 27.56m2
		Porch:	14.37m2
		Paving(rear in TOTAL 325.38	c Alf):66.01m2 m2 or 35.02sqs

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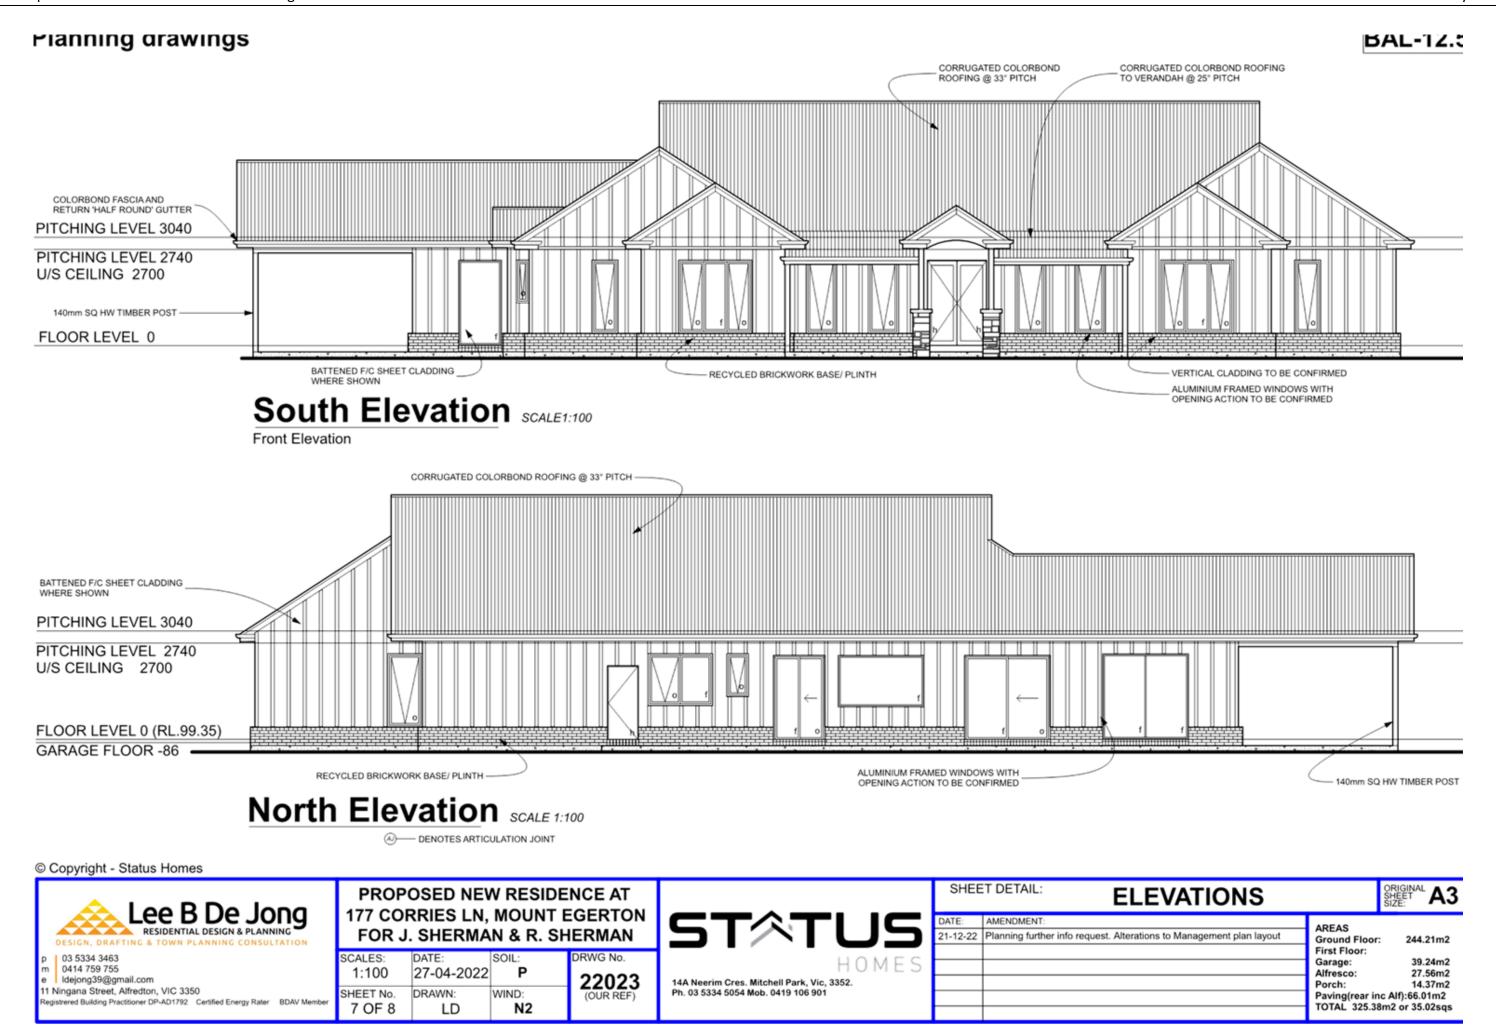



PROPOSED NEW RESIDENCE AT 177 CORRIES LN, MOUNT EGERTON FOR J. SHERMAN & R. SHERMAN

CALES:	DATE:	SOIL:	DRWG No.
1:100	27-04-2022	Р	22023
HEET No.	DRAWN:	WIND:	(OUR REF)
6 OF 8	LD	N2	` ′

14A Neerim Cres. Mitchell Park, Vic. 3352. Ph. 03 5334 5054 Mob. 0419 106 901

SHEET DETAIL: GROUND FLOOR PLAN			ORIGINAL SHEET SIZE:
DATE:	AMENDMENT:	ADEAG	
21-12-22	Planning further info request. Alterations to Management plan layout	AREAS Ground Floor First Floor:	: 244.21m2
		Garage:	39.24m2
		Alfresco:	27.56m2
		Porch:	14.37m2
			nc Alf):66.01m2
		TOTAL 325.3	8m2 or 35.02sqs



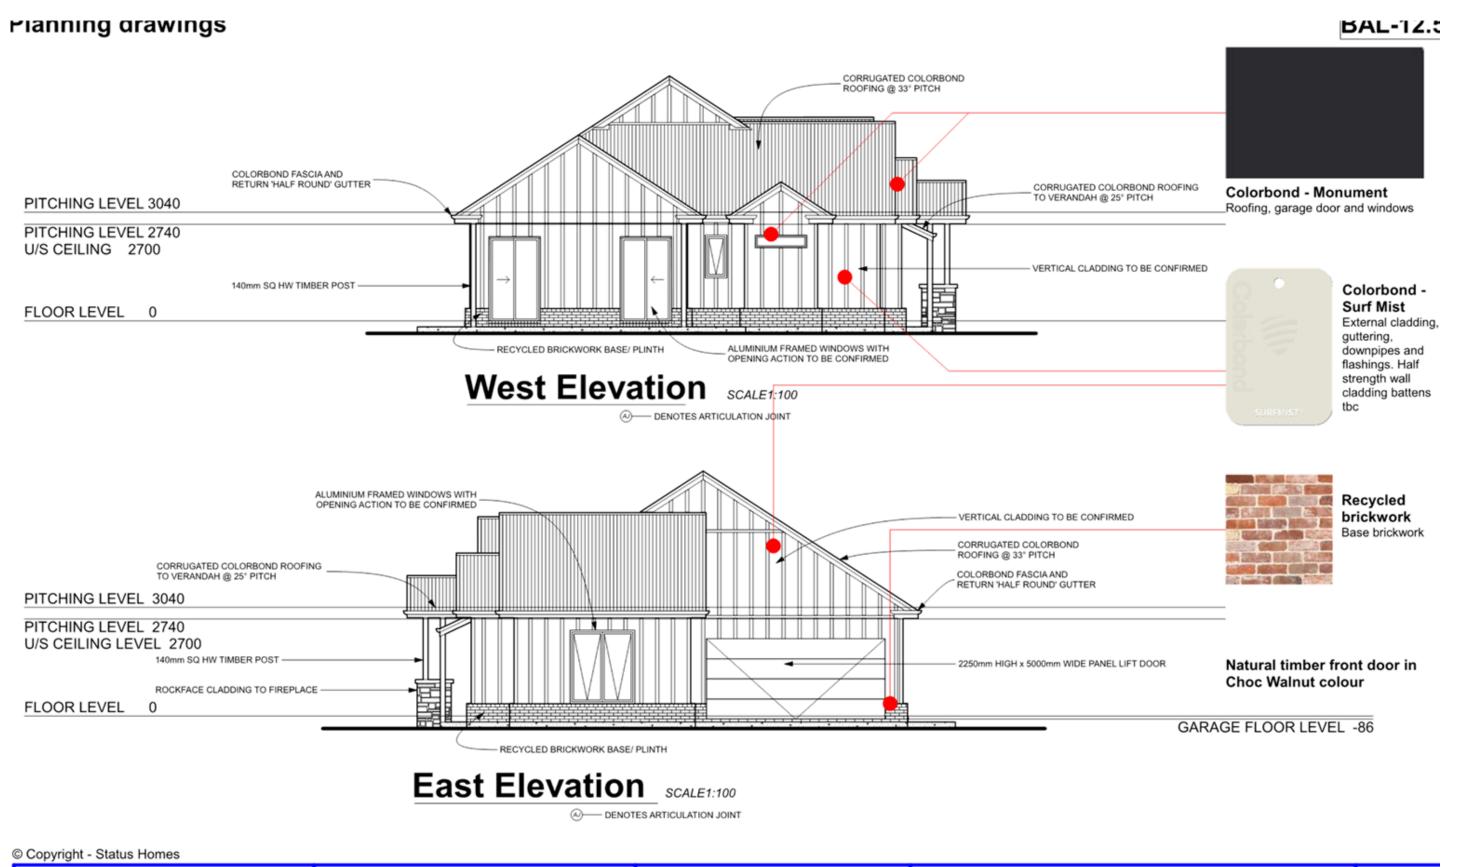



Item 7.3 - Attachment 1

PLAN OF SUBDIVISION

UNDER SECTION 22 OF THE SUBDIVISION ACT 1988

EDITION 1

PS903810E

LOCATION OF LAND

PARISH: **MERRIMU**

TOWNSHIP: SECTION:

CROWN ALLOTMENT: 11A & 11E (PARTS)

CROWN PORTION: 11 (PART)

VOL. 10171 FOL. 818 TITLE REFERENCE:

LOT 2 ON PS332882J LAST PLAN REFERENCE:

POSTAL ADDRESS: 190 LERDERDERG GORGE ROAD

DARLEY 3340 (at time of subdivision)

ZONE: 55 MGA 2020 CO-ORDINATES: E: 274 173

(of approx centre of land in plan) N: 5 831 110 Council Name: MOORABOOL SHIRE COUNCIL

EXPLANATORY NOTE:

EXPLANATORY NOTE:
WARNING THIS PLAN IS UNREGISTERED.
THIS PLAN WAS PREPARED TO BE CERTIFIED BY COUNCIL AND TO BE REGISTERED BY
THE REGISTRAR OF TITLES. AS ALTERATIONS MAY BE REQUIRED BY THE COUNCIL
AND THE REGISTRAR OF TITLES PRIOR TO REGISTRATION, FARREN GROUP PTY LTD
ACCEPTS NO RESPONSIBILITY WHATSOEVER FOR ANY LOSS OR DAMAGE SUFFERED
HOWSOEVER ARISING TO ANY PERSON OR CORPORATION WHO MAY USE OR RELY
UPON THIS PLAN FOR ANY OTHER REASON.
THIS PLAN MUST NOT BE REPRODUCED EXCEPT:

a) FROM THE ELECTRONIC VERSION HELD BY FARREN GROUP PTY LTD, AND
b) UNLESS THE REPRODUCTION INCLUDES THIS NOTE.

NOTATIONS

VESTING OF ROADS AND/OR RESERVES

NOTATIONS		
NIL	NIL	
IDENTIFIER	COUNCIL/BODY/PERSON	

NOTATIONS

DEPTH LIMITATION:

DOES NOT APPLY

SURVEY:

This plan is based on survey.

This survey has been connected to MERRIMU PM 2

In Proclaimed Survey Area No. -

STAGING:

This is not a staged subdivision.

PLANNING PERMIT:

EASEMENT INFORMATION

A - Appurtenant Easement E - Encumbering Easement R - Encumbering Easement (Road) LEGEND:

SECTION 12(2) SUBDIVISION ACT 1988 APPLIES TO ALL THE LAND IN THIS PLAN

Easement Reference	Purpose	Width (Metres)	Origin	Land Benefited/In Favour Of
E-1	SUPPLY OF ELECTRICITY	15	LP122988	LOTS ON LP122988
E-2	WATER SUPPLY	3.04	H967654	VOL. 9231 FOL. 102

admin@farrengroup.com.au

LAND SURVEYING - TOWN PLANNING - HYDROGRAPHIC MAPPING

74 Maribyrnong Street Footscray 3011

LICENSED SURVEYOR:

PETER J. FARREN

ORIGINAL SHEET SIZE: A3


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VERSION: 02

SHEET 1 OF 2

Item 7.4 - Attachment 1

Page 14

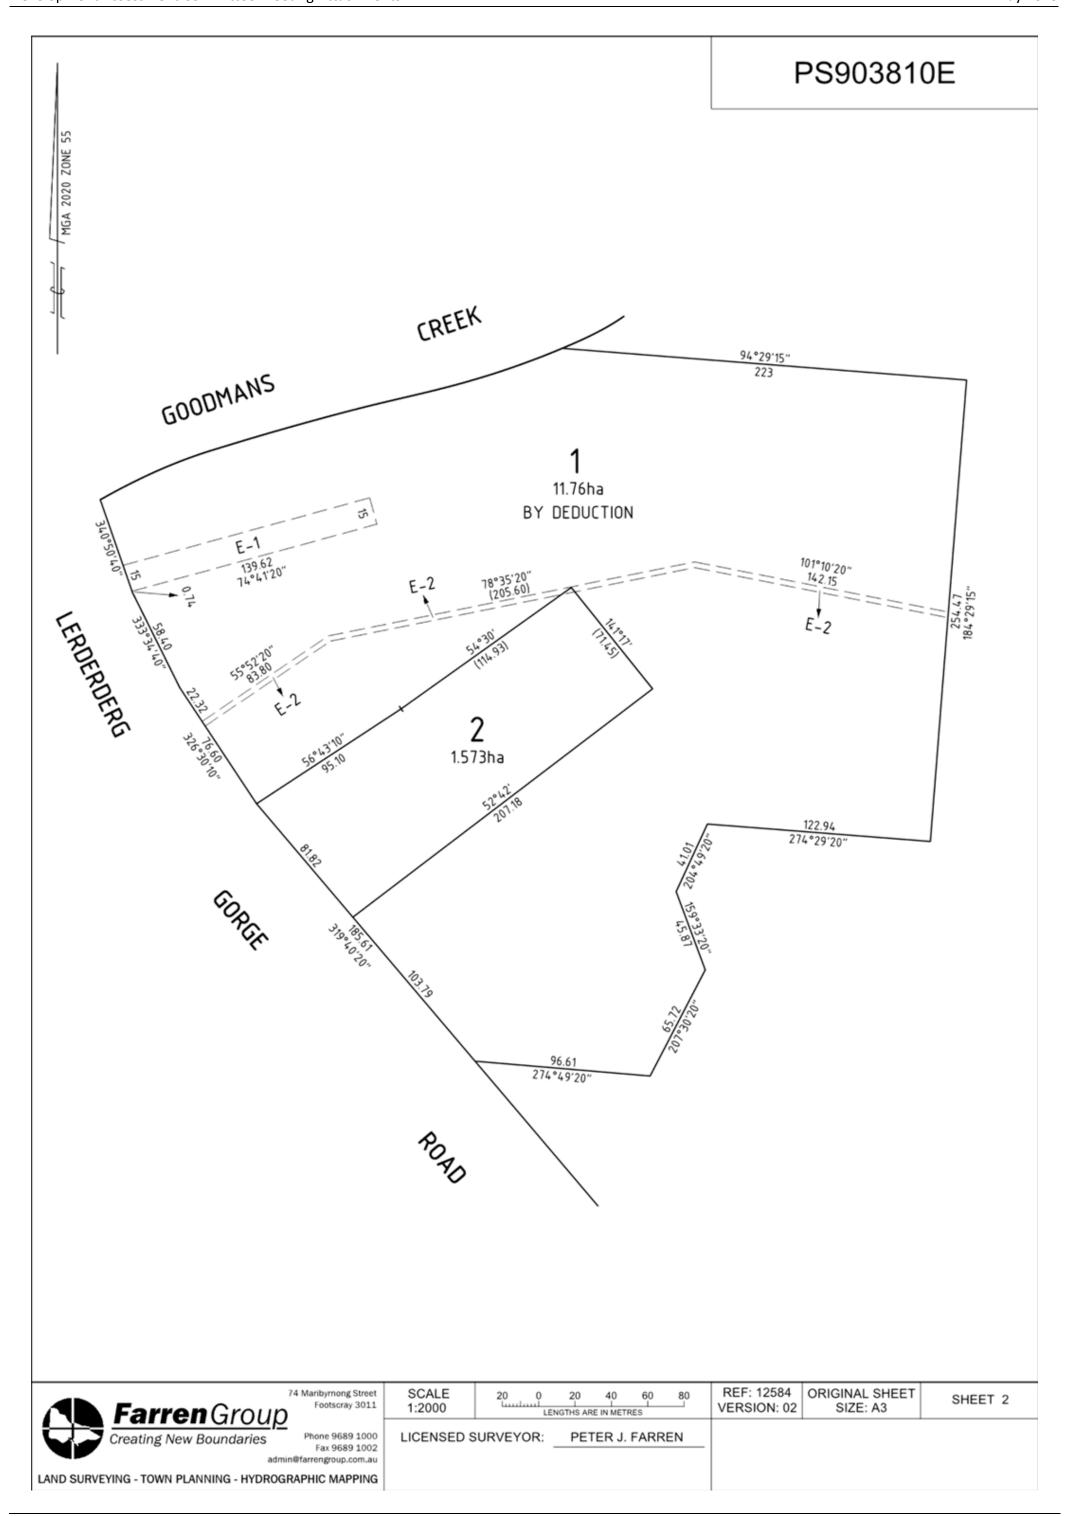

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Item 7.4 - Attachment 1 Page 16