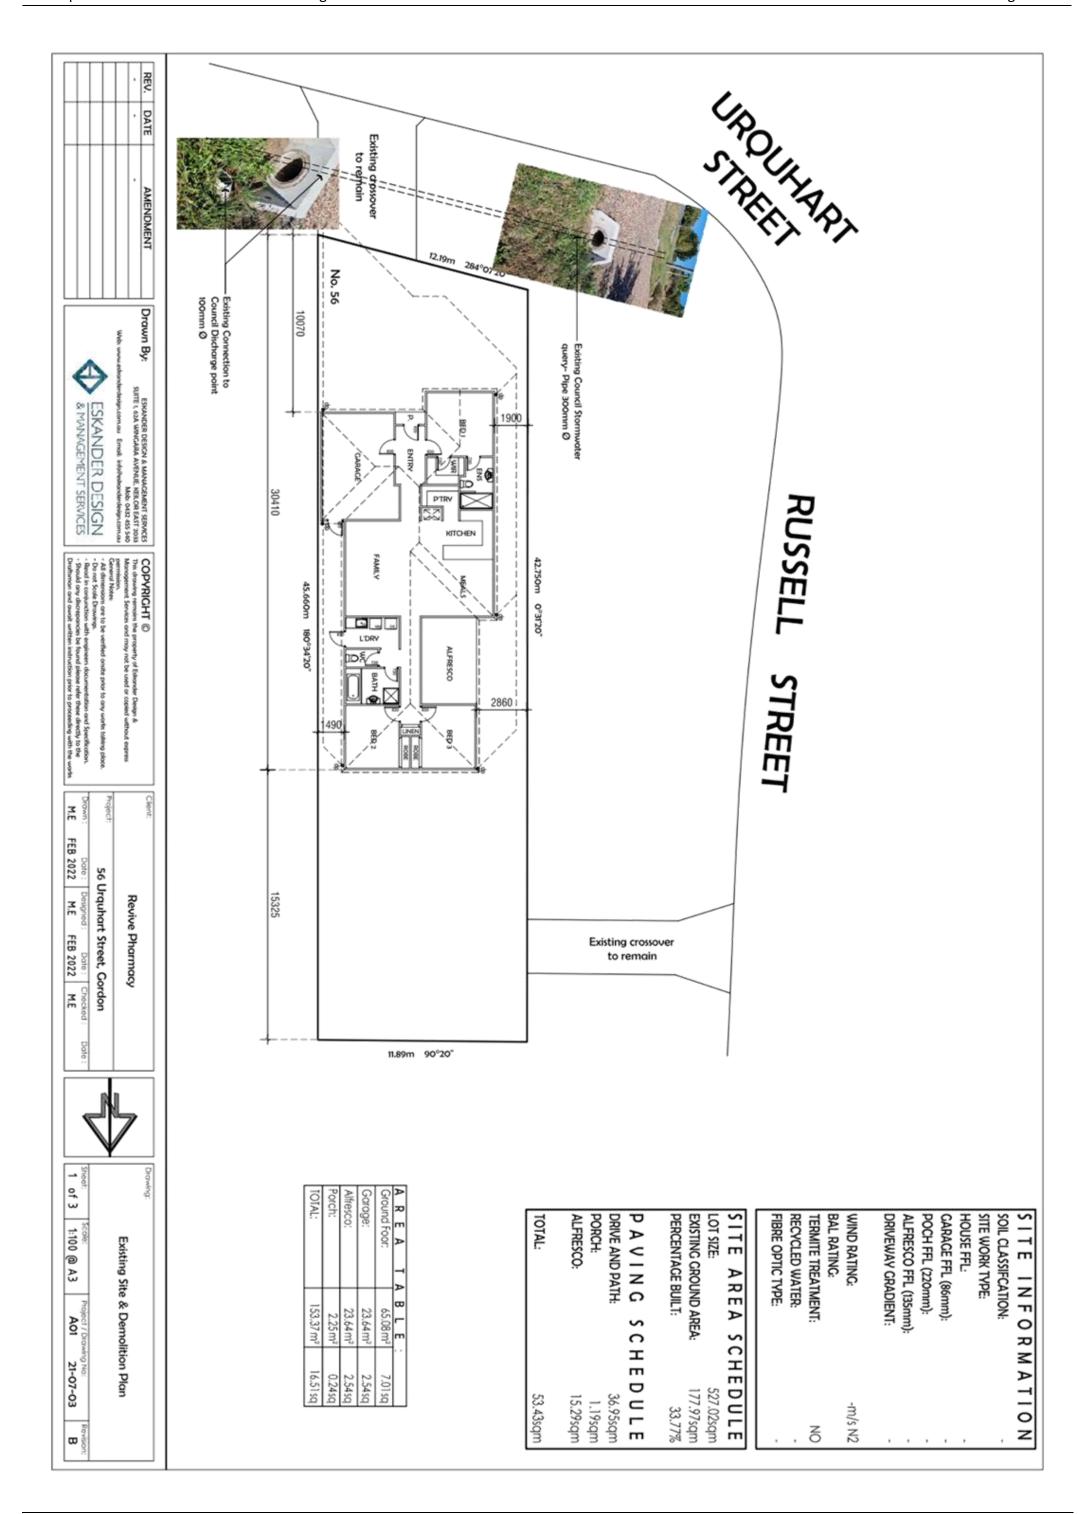
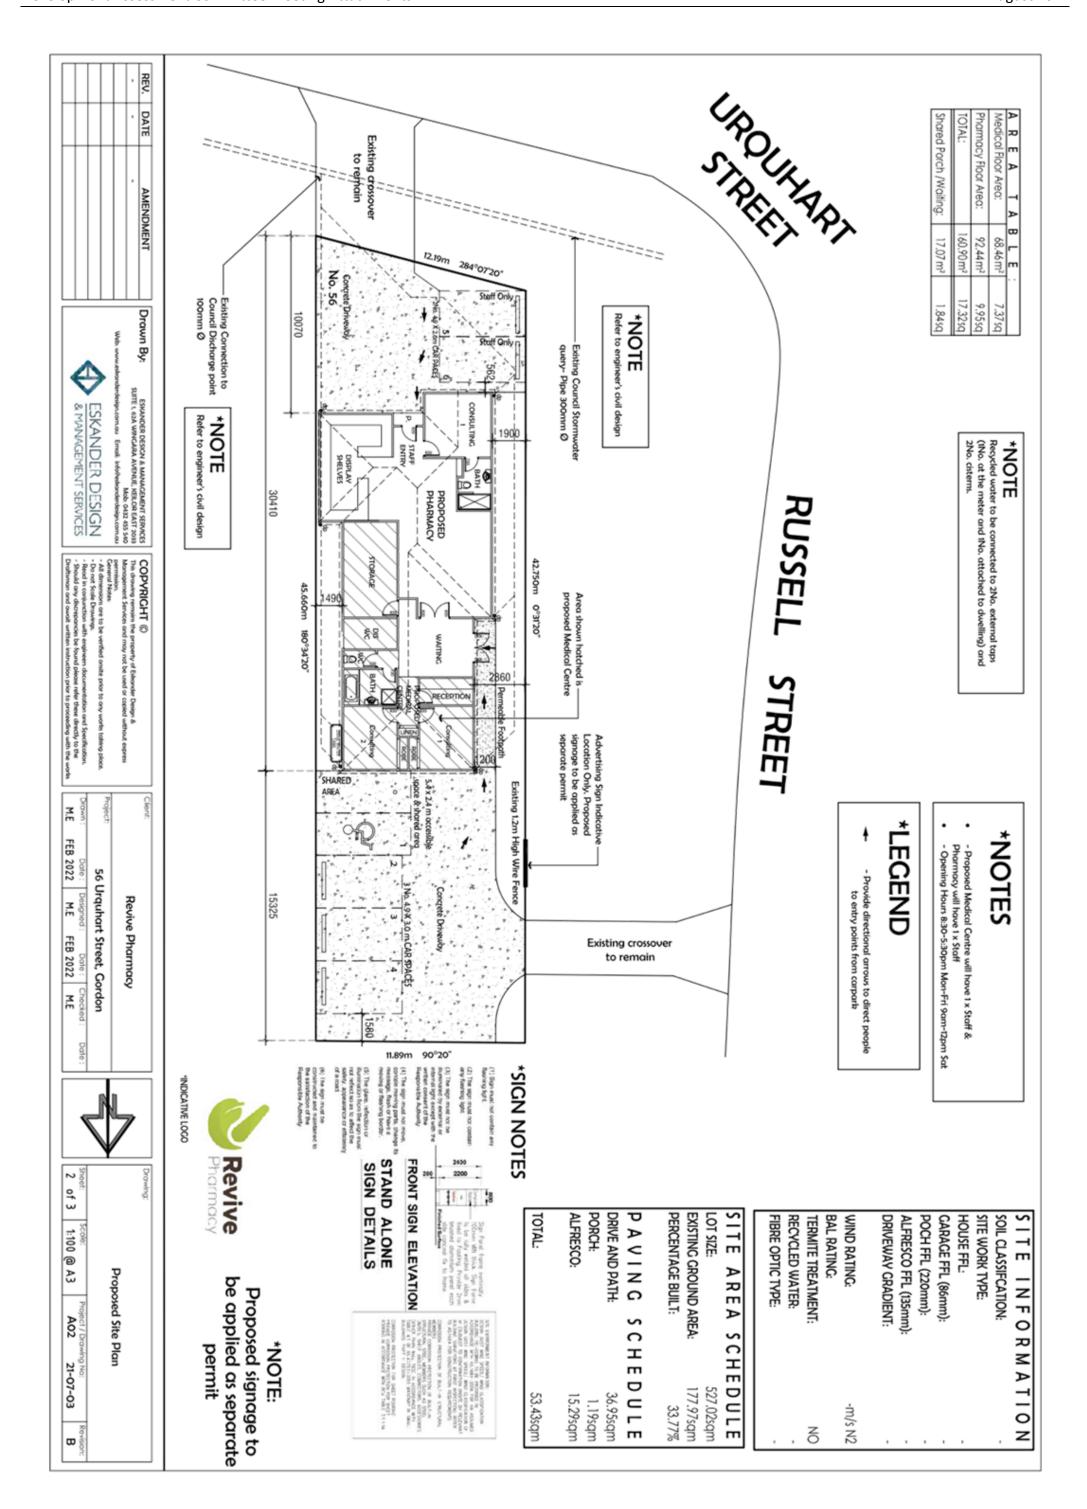



ATTACHMENTS

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FLOORING MATERIAL		GR	ADE	JOIST S	PACIN
19 THICK VICTORIAN HW		STANDARD		620	
19 THICK RADIATA PINE		STAN	DARD	5	10
PARTICLEBOARD SHEET FLOOR	600 SERIES		6	00	
FRAMING TIMBER		MAX. SPAN			
CEILING HEIGHT - 3000					
EFFECTIVE ROOF LENGTH - 1200	0		24		1
		S IS	CONT. OVER	NOMUM NOMO	AXMUM
MEMBER	SZE	SUPP. AT PONTS	SPANS	MAXIMUN SPACING	MAXO
SIZES FOR SINGLE STOREY A	ND UPPER	STOREY O	F 2 STORE	CONSTRU	CTION
BOTTOMPLATE	90 x 45	600	600		F5
TOP PLATE	90 x 45	600	600		F5
STUDS-COMMON	90 x 35	2400	2400	600	F5
	90 x 35	2700	2700	600	F5
	90 x 45	3000	3000	450	F5
STUDS-AT SIDES	90 x 45	2400	2400	1150	F5
OF OPENING	90 x 70	2400	2400	3000	F5
	90 x 70	2700	2700	1800	F5
	90×90	2700	2700	2700	F5
	90 x 90	3000	3000	1500	F5
UNTELS	90 x 35	1300			F1
(REFER TRUSS DESIGN)	140 X 35	1900			F1
	190 x 35	2400			F1
	240 X 35	3000			F1
	240 X 45	3200			F1
	290 X 45	3600			F1
NOGGINGS	70 x 35	600		1350	F5
BRACING	METAL ST	RAP - REF	ERAS. 1684		
ROOF BATTENS	75 X 38		900	900	F8
SIZES FOR LOWER STO	REY OF 2	STOREY	CONSTR	UCTION	
TOP AND BOTTOM PLATE	90 x 70	600	600		F5
STUDS COMMON	90 x 45	2400		600	F5
			-		-
	90 x 45	2700	-	450 450	F5
enine at ener	90 x 70	3000		450	F5
STUDS -AT SIDES OF THE	90 x 45	2400	2400	900	F5
OPENINGS	90 x 70	2700	2700	1500	F5
	90 x 90	2700	2700	2100	F5
	90 x 70	2700	2700	3900	F1
UNTELS	REFERTO	D EN GINEER	YS DETAILS		
FLOOR JOISTS	REFERTO) EN GINEER	YS DETAILS		
STRESS GRADE F17 REFERS TO STRESS GRADE F8 REFERS TO STRESS GRADE F7 REFERS TO STRESS GRADE F5 REFERS TO	INSEASONE INSEASONE	D HARDWO D OREGON	00		

VERTICAL BRICK JOINT FORMED ACCURATELY AND

FOOTINGS ARE TO COMPLY WITH AS 2870 AND NCC. PART 3.2. FOOTING & SLAB CONSTRUCTION:

EXCAVATE FOOTINGS & DRAINS AS SHOWN, KEEP EXCAVATIONS DRY & BACKFELL WITH APPROVED MATERIALS FREE OF ANY BUILDING DEBRIS

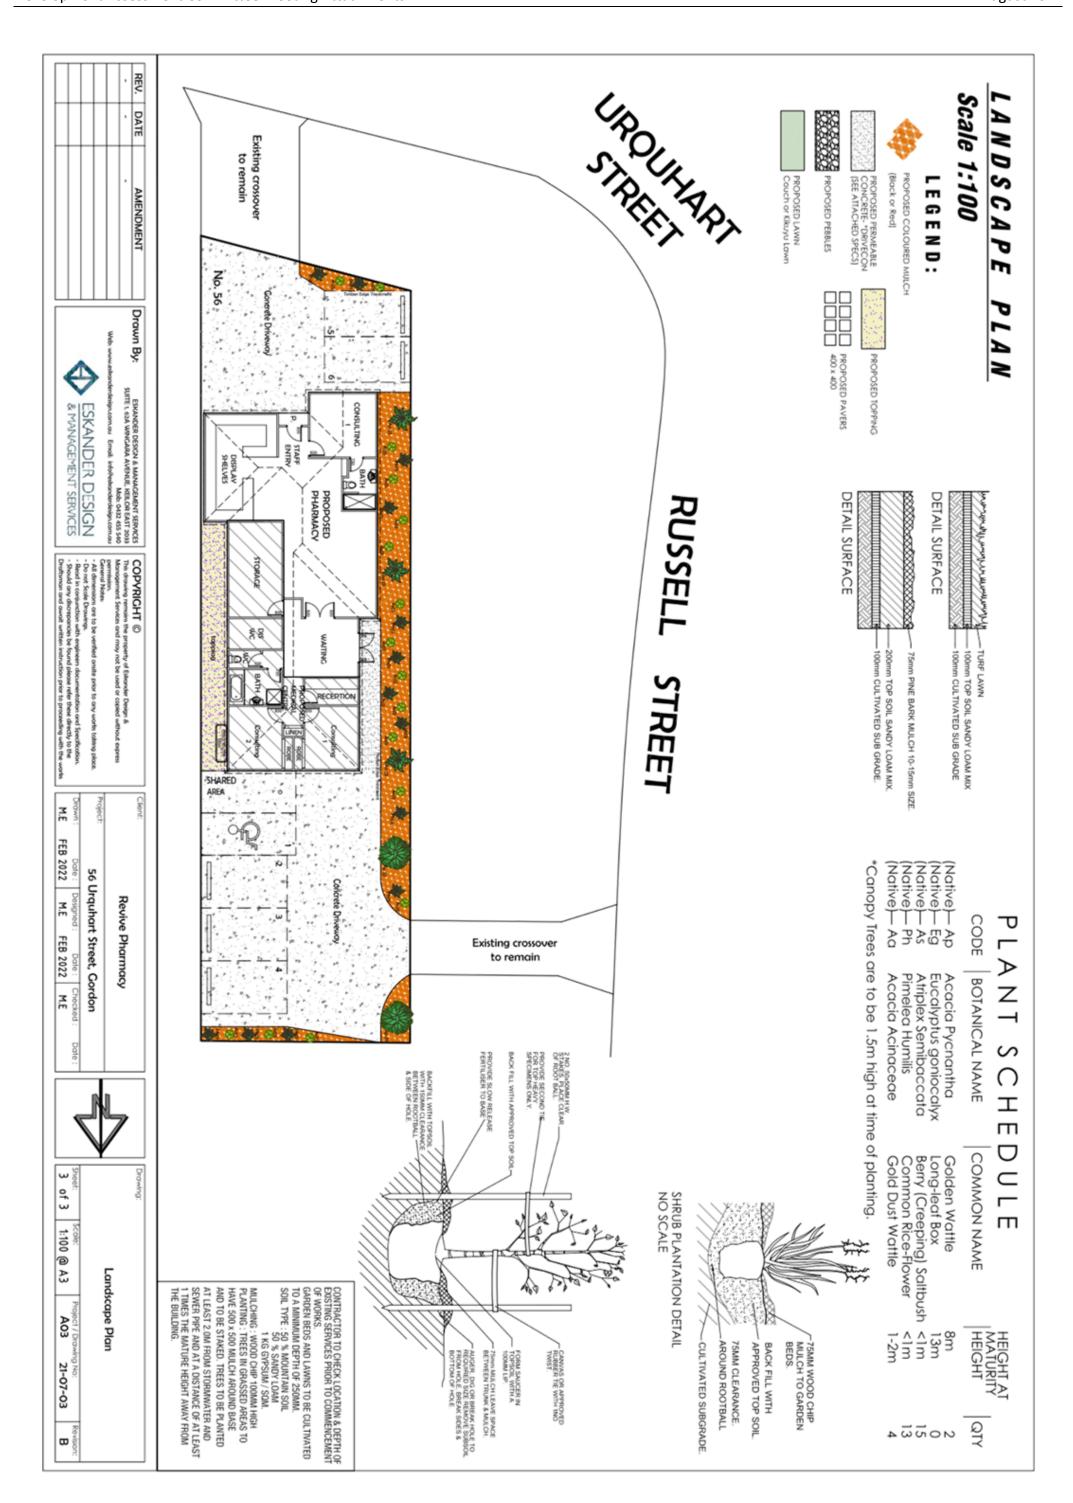CONCRETE SLAB & FOOTINGS: REFER TO STRUCTURAL ENGINEER'S DRAWINGS

CONDITIONS. USE 100 X 100MM REINFORCED

CONCRETE STUMPS SET 29MM MAX INTO CONCRETE

PAD FOOTINGS, UNLESS NOTED OTHERWISE BY

STRUCTURAL ENGINEER. THE CONCRETE PAD

FOR SLAB DETAILS, AND GEOTECHNICAL ENGINEER'S REPORT FOR FOUNDING DEPTHS AND

SOIL CLASSFICATION: THESE PLANS SHALL BE READ IN CONJUNCTION WITH THE SOIL REPORT.

FOOTINGS TO BE FOUNDED AT THE MINIMUM DEPTHS INDICATED IN THE SOIL REPORT. THE H.G.F.L. RECOMMENDS THAT FOOTINGS/SLABS & DRAINAGE TO BE DESIGNED & INSPECTED BY AN ENGINEER TO SATISFY THEIR REQUIREMENTS

90mm DIAM, CLASS 6 UPVC STORMWATER LINE LAID. TO A MINMUM GRADE OF 1.100 AND CONNECTED TO THE LEGAL POINT OF DISCHARGE AS DIRECTED BY LOCAL AUTHORITY REQUIREMENTS. PROVIDE INSPECTION OPENINGS AT 9000mm C/C & AT EACH CHANGE OF DIRECTION. THE COVER TO UNDERGROUND STORMWATER DRAINS SHALL BE NOT LESS THAN.

- 100mm UNDER SOIL
- 50mm UNDER PAVED OR CONC. AREAS 100mm UNDER UNREINFORCED CONC. OR
- PAVED DRIVEWAYS 75mm UNDER REINFORCED CONC. DRIVEWAYS
- 'REFER ENGINEER'S CIVIL PLAN

PROVIDE 10mm THICK PLASTERBOARD TO WALLS AND 10mm THICK PLASTER TO CELING, ALL WET AREAS SHALL HAVE AN APPROVED 10mm THICK WATERPROOF PLASTERBOARD OR HARDIES VILLABOARD INSTALLED IN STRICT ACCORDANCE

ALL GLAZING SHALL COMPLY WITH A.S. 1288 ALL HEAD HEIGHTS ARE AT 2100MM ABOVE FLOOR LEVEL UNLESS OTHERWISE NOTED. ALL SIZES ARE INDICATIVE. EXACT SIZES TO BE SPECIFIED BY WINDOW MANUFACTURER ALL MEASUREMENTS SHOWN ARE TO HARD SURFACE STRUCTURE TO LERANCE ARE TO COMPLY

WITH MANUFACTURERS ALLOWANCES. SITE CHECK REQUIRED ALL GLAZING IN BATHROOM, ENSUITES, SPA ROOMS OR THE LINE, INCLUDING SHOWER DOORS, SHOWER SCREENS, BATH ENCLOSURES, ASSOCIATED WINDOWS, WHERE THE LOWEST SIGHT LINE IS LESS THAN 2000MM ABOVE THE HIGHEST ABUTTING FINISHED FLOOR LEVEL, BOTTOM OF THE BATH OR

1) FOR FRAMED GLAZING, BE GRADE "A" SAFETY GLAZING IN ACCORDANCE WITH TABLE 3.6.5 OF THE

2) FOR FRAMELESS GLAZING. BE TOUGHENED SAFETY GLASS IN ACCORDANCE WITH TABLE 3.6.5 OF THE NCC WITH A MINIMUM THICKNESS OF 6MM.

REFER TO ELEVATIONS FOR SASH LOCATIONS ALL OPENING SASHES TO BE PROVIDED WITH WINDOW LOCKS, INCLUDING SLIDING DOORS. ALL DOORS & WINDOW SASHES TO WHOLE JOB TO

DAMP PROOF COURSES:

SHOWER BASE, MUST:-

CONTINUOUS DAMP PROOF COURSE AND CAVITY FLASHING MATERIAL SHALL BE NOM. 0.5MM THICK ALUMINIUM COATED IN BITUMEN, AND SHALL BE IN ACCORDANCE WITH WEATHER PROOFING OF MASONRY: PART 3.3.4.4, VOL.2, NCC. AND PROVIDED IN THE FOLLOWING LOCATIONS: SLAB LEVEL. COMBINED D.P.C. FLASHING. HEAD FLASHINGS TO OPENINGS. TURN INTO ANGLE LINTELS AND EXTEND ACROSS THE CAVITY, TURN UP NOT LESS THAN 150MM AND FIX TO TIMBER FRAME, UNDER TIMBER WINDOW SILL, ACROSS THE CAVITY AND TURNED DOWN AND EMBEDDED FOR THE FULL WIDTH OF OUTER LEAF OF BRICKWORK SET ONE COURSE BELOW BRICK-ON-EDGE SILL EXTEND FLASHING 100MM BEYOND ENDS OF OPENINGS/JAMBS AND LAP DPC MIN. 150MM AT JOINS.

WEEP HOLES:

PROVIDE WEEP HOLES AT EVERY FOURTH PERPEND ABOVE ALL CROSS CAVITY FLASHINGS IN EXTERNAL CAVITY BRICK SKINS TO HEIGHT AND WIDTH OF INSTALL SOLID-FUEL BURNING APPLIANCES IN ACCORDANCE WITH "HEATING APPLIANCES", PART 3.7.3. VOL. 2 OF THE NCC AND AS 2918.

HEATING APPLIANCE / FIR EPLACE:

HEARTH'S TO EXTEND MIN 300MM BEYOND THE

FRONT OF THE FIRE-PLACE/INSERT FIRE-PLACE

OPENING, IN ACCORDANCE WITH HEATING APPLIANCES', PART 3.7.3, VOL. 2 OF THE NCC.

OPENING AND 150MM BEYOND EACH SIDE OF THAT

LIGHT & VENTLATION:
THE AREA OF LIGHT TO HABITABLE ROOMS SHALL
ACHEVE THE MINIMUM 10% FLOOR AREA IN
ACCORDANCE WITH PART 3.8.4 VOL 2 OF THE NCC.

VENTILATION AND THE OPEN AREA OF WINDOWS

GALVANISED'. REFER ALSO ENGINEERS SPECIFICATIONS.

SUB-FLOOR VENTILATION:

PROVIDE MIN. 76 X 200 MM GALVANISED STEEL SUB-FLOOR VENTS @ MAX. 1.8 M SPACINGS IN BASE BRICK WALLING OR AS SPEC.

SMOKE DETECTORS:

S. - DENOTES HARDWIRED AND INTERCONNECTED SMOKE DETECTORS COMPLYING WITH AS 3786. CEILING MOUNTED WHERE INDICATED ON DESIGNER'S DRAWINGS

TIMBER FLOOR WALL AND ROOF FRAMING

ALL WORKS TO BE CARRIED OUT IN STRICT ACCORDANCE WITH AS 1684 "TIMBER FRAMING

CORROSION PROTECTION

ALL STRUCTURAL STEEL MEMBERS, WALL TIES AND ROOF SHEETS TO BE AS PER NCC 3.4.2.2 MUST HAVE A MIN COATING CLASS IN ACCORDANCE WITH AS 1397 of Z275 (250 grams of zinc per metere) of

TERMITE PROTECTION:

UNLESS OTHERWISE SPECIFIED. GROUND AREA BELOW STRUCTURE TO BE TREATED WITH CHEMICAL SPRAY PROTECTION AGAINST TERMITES IN ACCORDANCE WITH AS 3660.1, AND TERMITE RISK MANAGEMENT: PART 3.1.3, VOL. 2 OF THE NCC.

WALL SARKING: PROVIDE DOUBLE-SIDED REFLECTIVE FOIL WALL SARKING AS SPECIFIED TO ALL NEW EXTERNAL

VERTICAL ARTICULATION JOINTS:

FORM 10MM WIDE VERTICAL JOINTS IN BRICKWORK WHERE SHOWN ON DRAWINGS AND IN ACCORDANCE WITH PART 3.3.1.8 OF THE NCC "VERTICAL ARTICULATION JOINTS. USE APPROVED ELASTOMASTIC SEALANT OVER COMPATIBLE CLOSED CELL BACKING ROD. USE 'ABEY' STAINLESS STEEL EXPANSION TIES ACROSS CONTROL JOINTS. JOINTS ON FIRE RATED BOUNDARY WALLS TO BE FILLED WITH TYCO FYREFLEX OR OTHER APPROVED FIRE RATED JOINT SEALANT STRICTLY IN ACCORDANCE WITH MANUFACTURERS INSTRUCTIONS FOR USE. MAX SPACINGS ARE TO BE

SKYLIGHTS:

SKYLIGHTS TO BE 'VELUX' OR MODELS OF TYPES NOTED WITH LAMINATED HEAT-STOP GLASS AND, WHERE NOTED, REMOTE WINDERS AND FLYSCREENS INSTALLED TO MANUFACTURER'S

WET AREAS: WET AREA WALL & FLOOR FINISHES TO COMPLY WITH WET AREAS' PART 3.8.1, VOL. 2 OF THE NCC.

BATHROOM & ENSUITE FLOORS:

CERAMIC OR STONE TILES OVER 15MM THICK HARDIES' COMPRESSED FIBRE CEMENT SHEET SUBSTRATE LINING WALLS GENERALLY: CERAMIC OR STONE TILES OVER 10MM THICK W.R. GRADE BORAL OR GYPROCK PLASTERBOARD SHEET SUBSTRATE LINING. SHOWER AND BATH RECESS WALLS AND HOBS: SELECTED CERAMIC OR STONE TLES OVER 6MM THICK HARDIES' VILLABOARD FIBRE CEMENT SHEET LINNG.

BATHROOM & ENSUITE MECHANICAL VENTILATION: BATHROOM, POWDER ROOM & ENSUITE MECHANICAL VENTILATION OF A MINIMUM 25US

BATHROOM / ENSUITE / POWDER ROOM HINGE DOORS:

ALL HINGED DOORS TO BATHROOMS. ENSUITES & DOOR TO BE ADJUSTED ACCORDINGLY.

DUCTED TO OUTSIDE AIR IN ACCORDANCE WITH AS

PROVIDE 2000 LITRE RAINWATER TANKS - MIN. ROOF CATCHEMENT OF 50m2. THE TANKS ARE TO BE CONNECTED TO THE SANITARY FLASHING SYSTEM.

CONCRETE STEP DETAIL:

GENERAL:
- THE SIZE OF TREADS AND RISERS SHALL BE CONSTANT AND THE SUM OF 2 TIMES RISERS HEIGHT PLUS GOING (2R+G) SHALL BE GREATER THAN 550mm AND LESS THAN 700mm, HANDRALS SHALL BE AT A MINIMUM HEIGHT OF 865mm ABOVE TREAD NOSINGS OR 1000mm ABOVE ADJACENT RAMPS AND OTHER FLOOR SURFACES.

THE OWNER, BUILDER, SUBCONTRACTOR SHALL VERIFY ALL DIMENSIONS, LEVELS, SETBACKS AND SPECIFICATIONS PRIOR TO COMMENCING ANY

WORKS OR ORDERING MATERIALS AND SHALL BE

RESPONSIBLE FOR ENSURING THAT ALL BUILDING WORKS CONFORM TO THE BUILDING CODE OF

AUSTRALIA, A.S. CODES (CURRENT EDITIONS)

BUILDING REGULATIONS, LOCAL BY-LAWS AND

TOWN PLANNING REQUIREMENTS, REPORT ALL DISCREPANCIES TO THIS OFFICE FOR

CLARFICATION, ANY CHANGES TO THE ORIGINAL

ALL WORK TO COMPLY WITH THE NATIONAL

REQUIREMENTS.

PLANS HAS TO BE SUBMITTED TO ENGINEER AND

CONSTRUCTION CODE VOL.1 & VOL.2 RELEVANT AUSTRALIAN STANDARDS AND LOCAL AUTHORITIES

INTO LEGAL POINT OF DISCHARGE AS DIRECTED BY

LOCAL COUNCIL BUILDER AND/OR PLUMBER IS TO VERFY LOCATION & R.L's AND IL'S OF EXISTING PITS AND PIPES, PRIOR TO THE COMMENCEMENT OF ANY


THIS DRAWING IS TO BE READ IN CONJUNCTION WITH ENGINEERS STRUCTURAL DRAWING AND

COMPUTATION AND ALL OTHER RELEVANT DOCUMENTATION

WHERE A HANDRAIL IS NOT ADJACENT TO A WALL PROVIDE BOTTOM RAIL 125mm MAX. ABOVE TREAD NOSINGS OR FLOOR, PROVIDE 125mm MAX, CLEAR BETWEEN RALS OR BALUSTERS, HORIZONTAL RALS SHALL NOT BE PLACED BETWEEN 150mm AND 760mm ABOVE FLOOR OR TREAD NOSINGS.

CONCRETE:

AND DOORS SHALL ACHIEV THE MINIMUM 5% FLOOR AREA IN ACCORDANCE WITH PART 3.8.5 VOL. 2 OF SHALL BE MINIMUM THICK, EXCLUSIVE OF TOPPINGS SHALL BE OF MINIMUM 20 GRADE MASS CONCRETE SHELL BE STEEL TROWELLED GRANOLITHIC FINISH STEEL LINTELS & STEELWORK: ALL EXTERNAL STEEL LINTELS AND EXPOSED STRUCTURAL STEELWORK TO BE 'HOT DIPPED

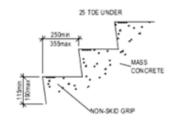

TIMBER STEP DETAIL: EXTERNAL STEPS IN ACCORDANCE WITH PART 3.9, VOL 2 OF THE NCC THE GOING AND RISER OF A FLIGHT OF STAIRS IN A


No. OF RISERS BEFORE A LANDING IN A SINGLE FLIGHT OF STARS SHALL NOT EXCEED 18 RISERS.

HANDRAILS SHALL BE AT MINIMUM HEIGHT OF 865mm ABOVE NOSING OF TREADS AND 1000mm ABOVE

AND RAILS SHALL BE PROVIDED ALONG EACH SIDE OF A STAIRWAY IF THE WIDTH OF THE STAIRWAYS EXCEEDS 2000mm.

THE WIDTH OF A STAIR (MEASURED CLEAR OF HANDRAILS AND OBSTRUCTIONS) SHALL BE

BALUSTRADES TO BE CONSTRUCTED IN A WAY THAT ANY OPENINGS DOES NOT PERMIT A 125mm SPHERE TO PASS THROUGH IT AND FOR BOTTOM RAILS THE SPACE IS TESTED ABOVE THE NOSINGS.

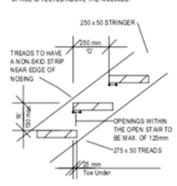

GOING AND RISERS SHALL NOT EXCEED FOLLOWING

	RISE	R (R)	GOING (G)		QUANTITY (2R+G)	
Stairs	Max. 190		Max. 355	Min. 250	Max. 700	Min. 550




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KANE & ERIN Location: **529 SWAN ROAD** DARLEY,

VICTORIA


Project Name **CLIFF VIEWS**

GENERAL NOTES

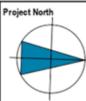



12_000 Drawing No: WD100



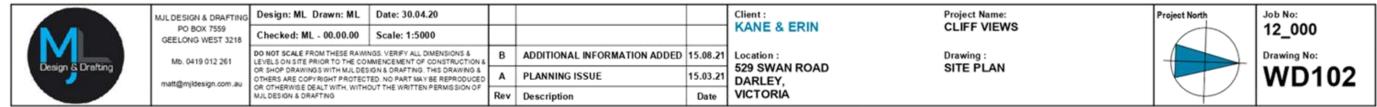




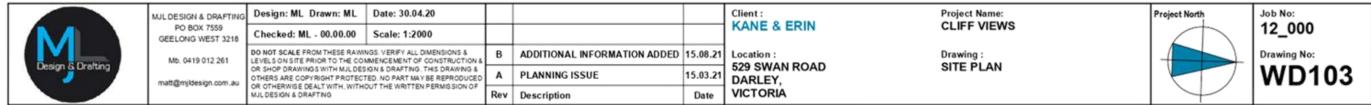


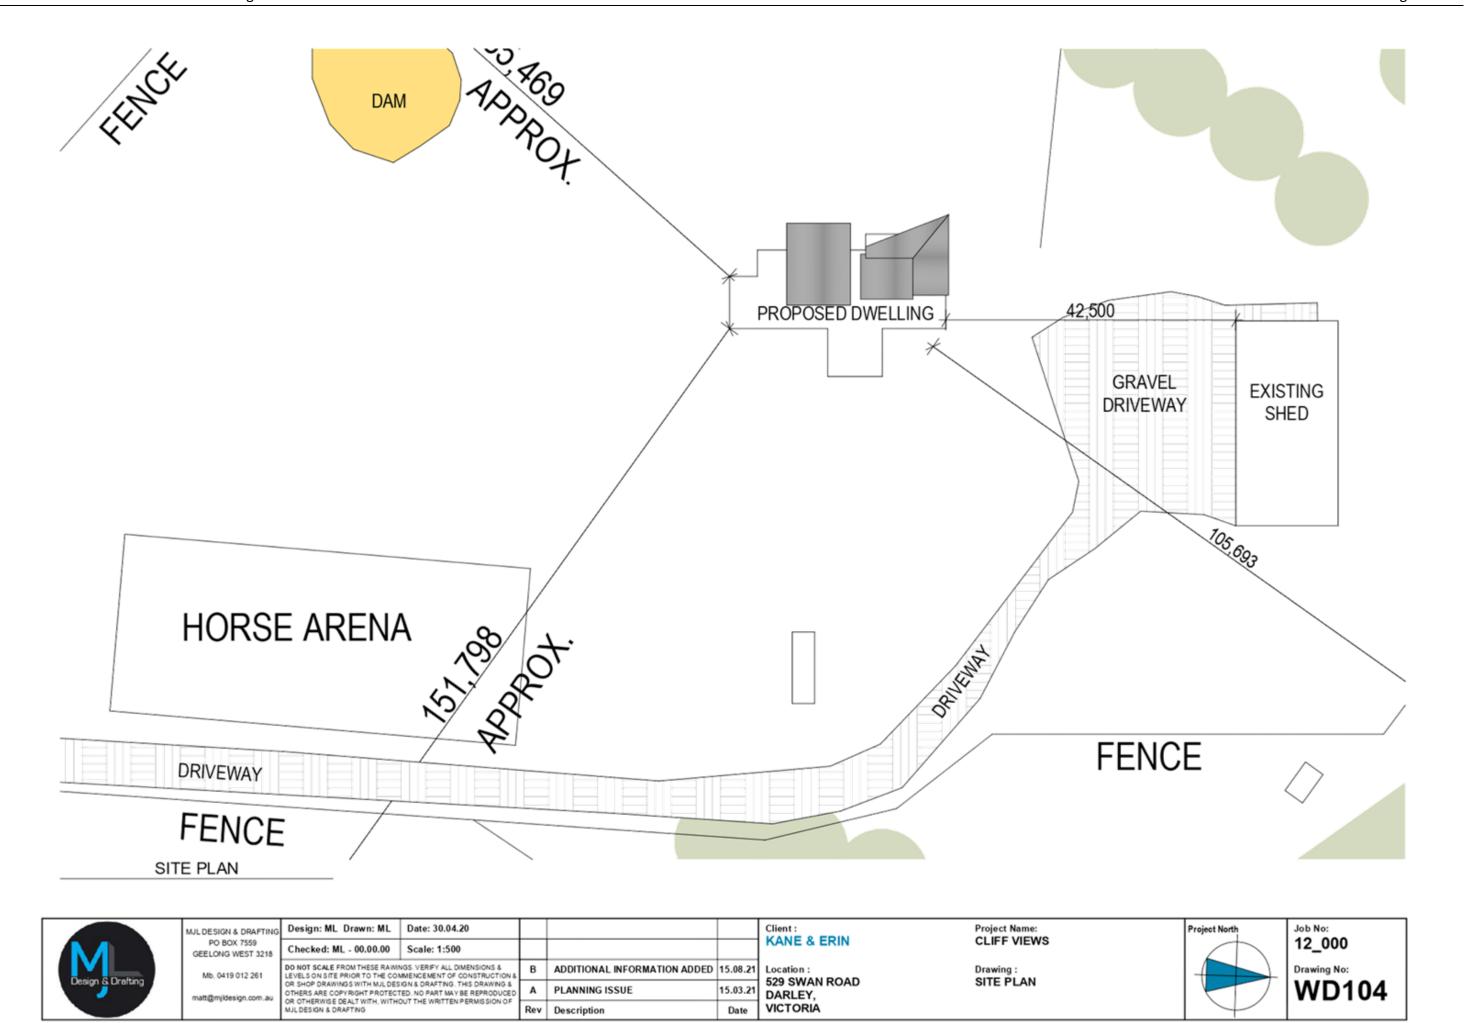


Item 7.2 - Attachment 1

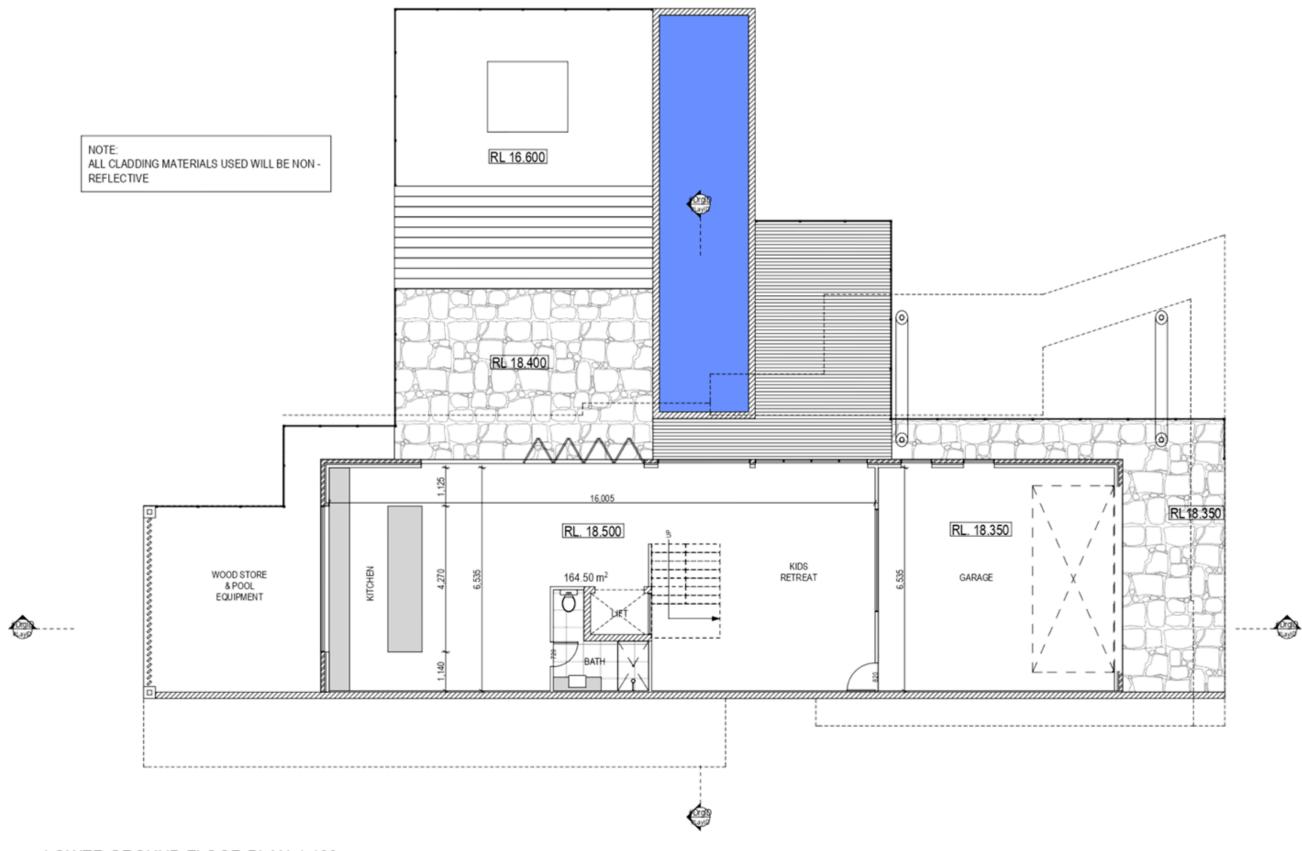


LOWER GROUND FLOOR PLAN 1:100

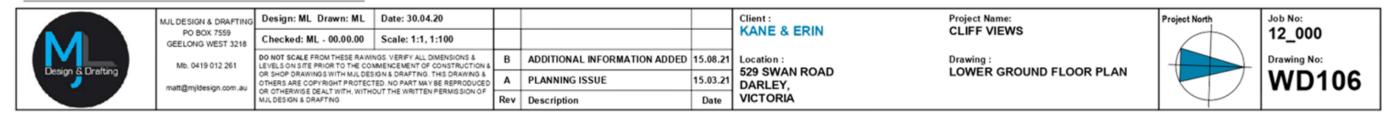


Item 7.2 - Attachment 1

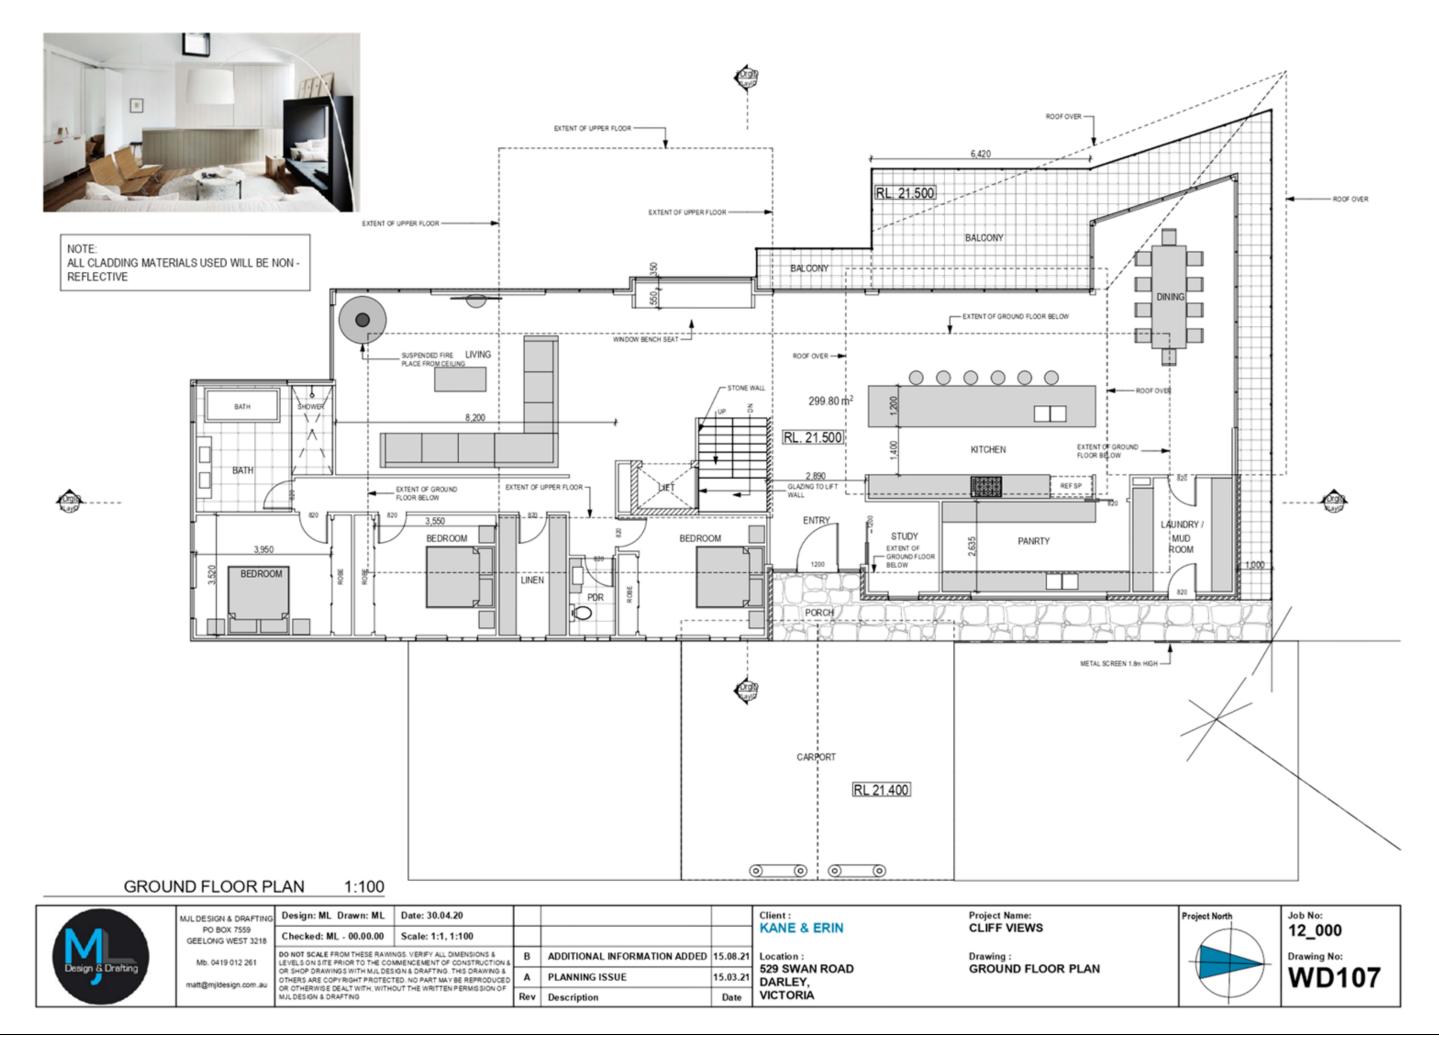

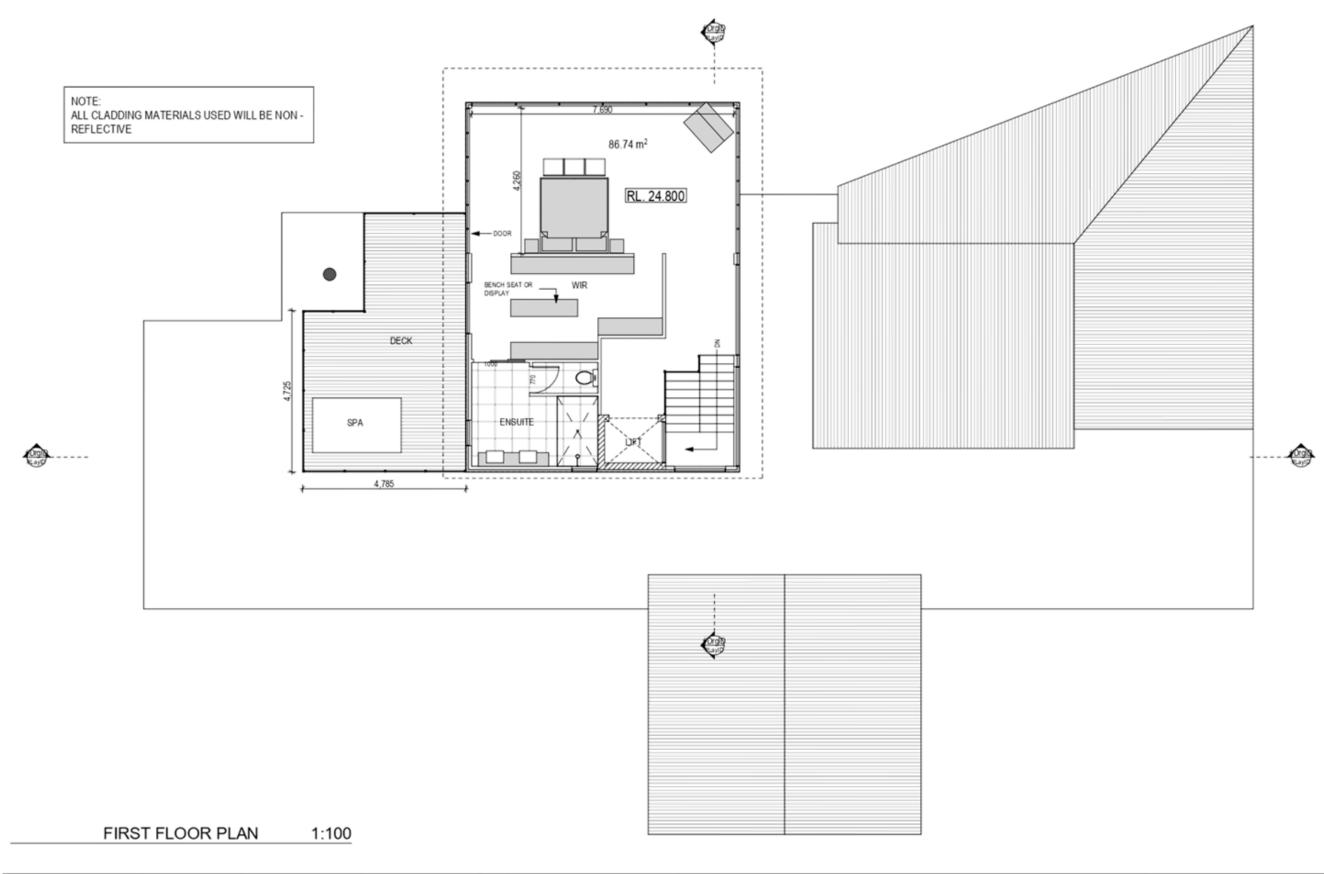

Client: KANE & ERIN Project Name: CLIFF VIEWS Design: ML Drawn: ML Date: 30.04.20 MJL DESIGN & DRAFTING 12_000 PO BOX 7559 Checked: ML - 00.00.00 Scale: 1:1, 1:100 GEELONG WEST 3218 DO NOT SCALE FROM THESE RAWINGS. VERIFY ALL DIMENSIONS & LEVELS ON SITE PRIOR TO THE COMMENCEMENT OF CONSTRUCTION & OR SHOP DRAWINGS WITH MULDESIGN & DRAFTING. THIS DRAWING & OTHERS ARE COPYRIGHT PROTECTED. NO PART MAY BE REPRODUCED OR OTHERWISE DEALT WITH, WITHOUT THE WRITTEN PERMISSION OF MULDESIGN & DRAFTING. Location : 529 SWAN ROAD DARLEY, ADDITIONAL INFORMATION ADDED 15.08.21 Drawing: FIRST FLOOR PLAN Drawing No: Mb. 0419 012 261 **WD108** Α PLANNING ISSUE 15.03.21 VICTORIA Description

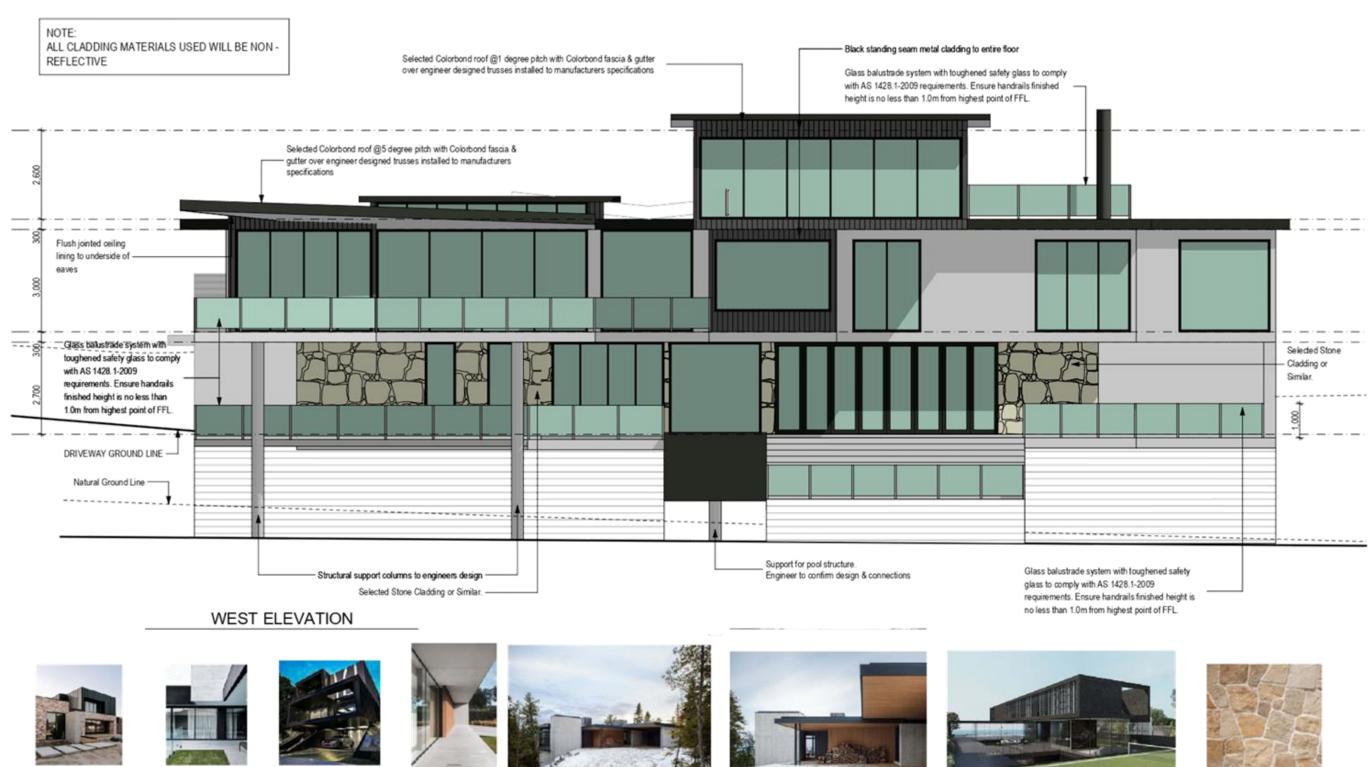



BRICKWORK CLADDING

JUL DESIGN & DRAFTING PO BOX 7559 GEELONG WEST 3218 Mb. 0419 012 261

LIGHT GREY RENDER

STANDING SEAM CLADDING WINDOWS & SOFIT LININGS Design: ML Drawn: ML Date: 30.04.20 Checked: ML - 00.00.00 Scale: 1:100, 1:255.78

MULDESIGN & DRAFTING

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CONCRETE CLADDING & TIMBER CLADDING

TIMBER SOFIT LININGS




TIMBER SCREENING

STONE WALL CLADDING


KANE & ERIN Location: **529 SWAN ROAD** DARLEY, VICTORIA

Project Name: **CLIFF VIEWS**

Drawing: **ELEVATIONS**

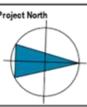

12_000 Drawing No: **WD200**

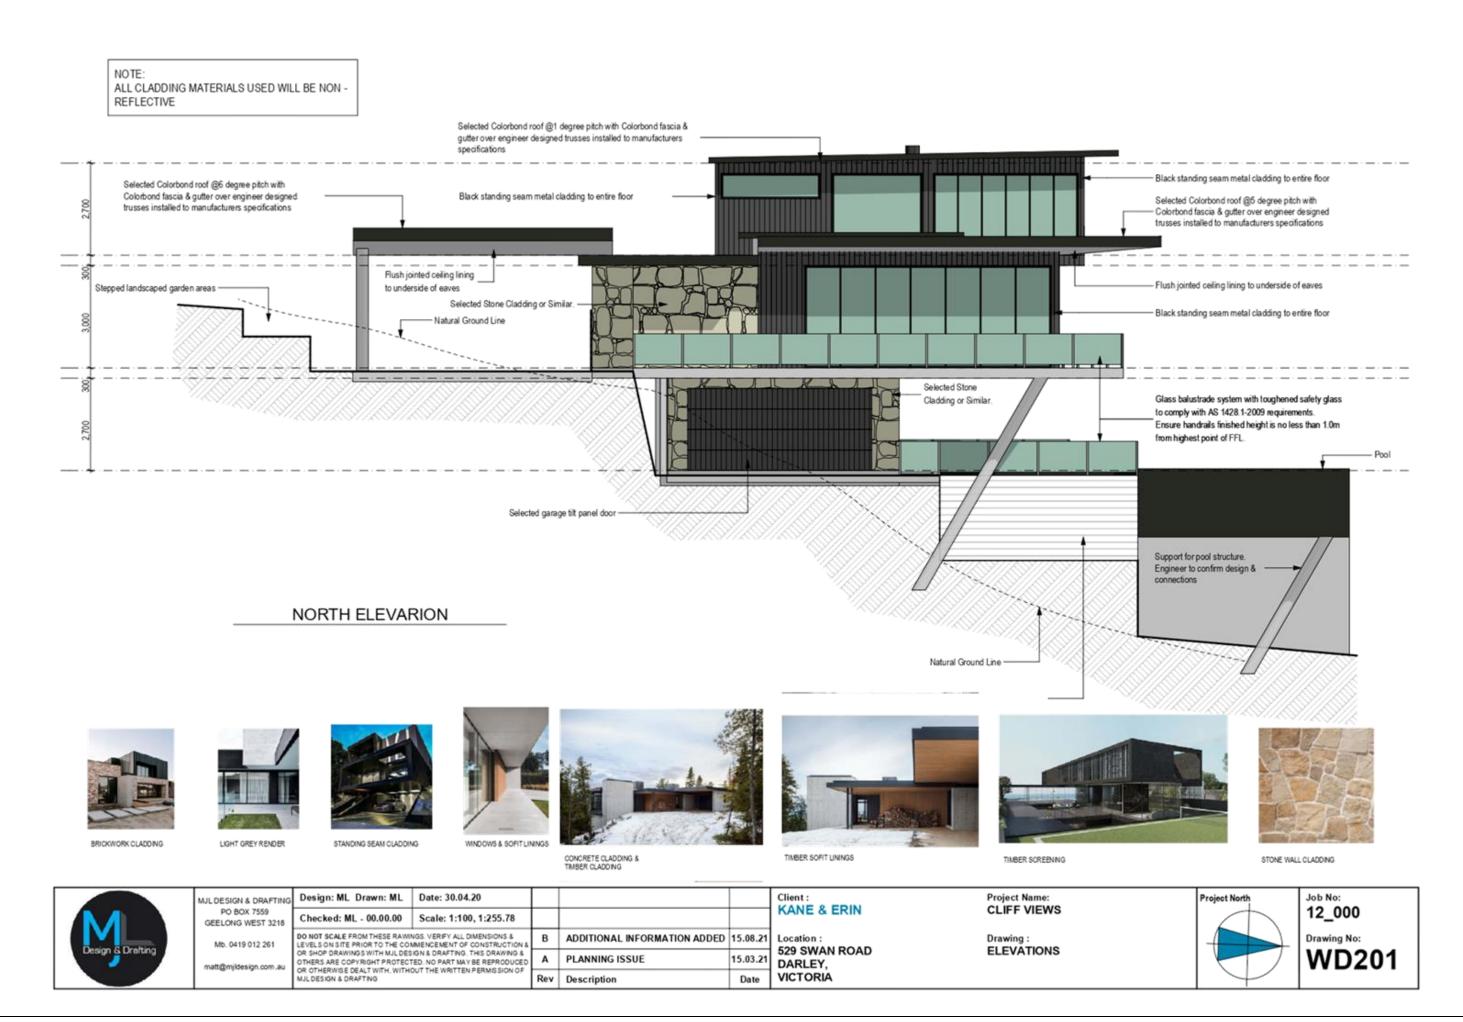



EAST ELEVATION



BRICKWORK CLADDING



LIGHT GREY RENDER



STANDING SEAM CLADDING











CONCRETE CLADDING & TIMBER CLADDING

TIMBER SCREENING

STONE WALL CLADDING

MJL DESIGN & DRAFTING PO BOX 7559 GEELONG WEST 3218 Mb. 0419 012 261

Date: 30.04.20 Design: ML Drawn: ML Checked: ML - 00.00.00 Scale: 1:100, 1:255.78 DO NOT SCALE FROM THESE RAWINGS, VERIFY ALL DIMENSIONS & LEVELS ON SITE PRIOR TO THE COMMENCEMENT OF CONSTRUCTION & OR SHOP DRAWINGS WITH MALDESIGN & DRAFTING. THIS DRAWING & OTHERS ARE COPYRIGHT PROTECTED, NO PART MAY BE REPRODUCED OR OTHERWISE DEALT WITH, WITHOUT THE WRITTEN PERMISSION OF MILDESIGN & DRAFTING. ADDITIONAL INFORMATION ADDED 15.08.21 Α PLANNING ISSUE Description


KANE & ERIN

Location: **529 SWAN ROAD** 15.03.21 DARLEY, VICTORIA


Date

Project Name: **CLIFF VIEWS**

Drawing: **ELEVATIONS**

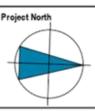

12_000 Drawing No: **WD202**

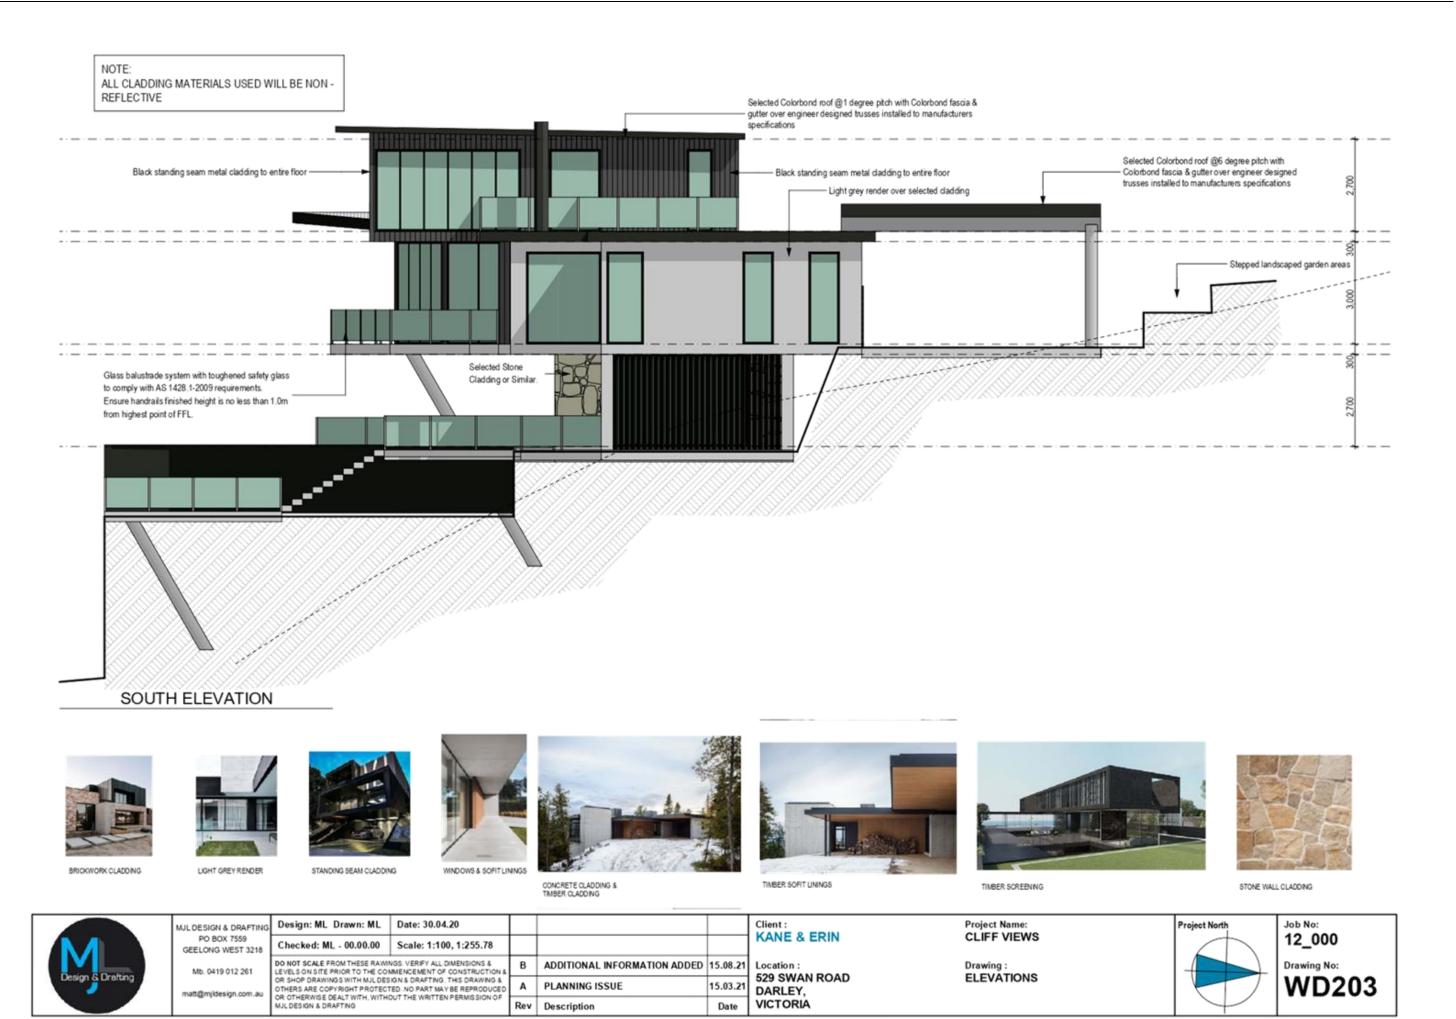

BUSINESS AND FARM MANAGEMENT PLAN

1. ADDRESS of property

Lot 2, 529 Swans Road, Darley 64 Acres

2. Category and classification of land

The site is zoned Farming (FZ)

3. INTRODUCTION

This farm management plan describes the development and use of the property at Lot 2, 529 Swans Rd, Darley for the purpose of operating an "Equine breeding, training and management facility." This facility will provide

- a. a breaking and training program
- b. a re-education program for horses and their owners
- c. a rescue and re-education centre for ex racehorses
- d. It will also provide care to injured or ill horses when their owners themselves are unable to care for them.
- e. a horse breeding program

The level of training and care and customer service required in this business dictates that the owners must reside on the property in order to provide the appropriate level of care and management of the horses at all times which includes but is not limited to any emergencies, ongoing treatment of sick animals, coordinate with clients, contractors and suppliers where required. It is also vital for the success of the business that clients know that their horses are being monitored 24/7. A permanent residence onsite will also provide the land use to be economically viable for a working family to reside and work their farm.

The business (*Torlea Park* 25466850350) is owned by Erin Cubley and managed by Erin and her partner Kane McQuarrie who will both reside in the new dwelling onsite, to manage the business and provide appropriate 24 hour care to the horses.

4. BUSINESS SUMMARY

The activity will require ongoing investment in infrastructure as the animals will need very close supervision due to the required husbandry practices.

The enterprise has three key specialised components.

- a. breeding, foaling and training services.
- b. breaking, training and education / re-education programs
- c. a convalescence facility for the local horse industry.

Each of these components have specific infrastructure needs, which are / will be developed.

1. Experience and Capability of the Owners/Operators

Business owner Erin Cubley and her partner Kane McQuarrie will both reside permanently in the new home on the property. Erin has 20 + years' experience in the equine industry as a horse rider, breaker and trainer, plus assisting with a family horse breeding business.

Both Erin and Kane run their own successful businesses external to the property and have the relevant customer service, technical and business management skills to operate the family farm business. This combines with their long experience in the equine industry.

The onsite home will enable them to optimize the effective use of the property and grow this business.

Financial capability:

The two owners each have their own successful business external to the farm, which should ensure sufficient income to manage the transition to a profitable horse enterprise within 24 months.

3. Farm business model

Services to be provided include;

- · Provision of breeding services.
- · Training and re-educating for horses,
- Riding instruction.
- Provision of daily equine management services including but not limited to; Daily feeding, monitoring, rugging when required, exercise for rehabilitation and medical care.
- Arrangement and monitoring of Professional services including veterinarian, equine dentist, physio, farrier etc.
- Short term accommodation for horses who are rehabilitating from illness or injury
- 24/7 management onsite of horses in care.
- 24/7 access to owners whose horses are in care.

It is expected that the facility will accommodate up to 8 horses in total at any one time. This number is based on the capability of the land, with appropriate stable / paddock rotation.

4. Access to the Property and site details

Access to the property is provided via a fully sealed road.

Access to the equine facility will be via secured gates at the front of the property. Horse owners and third parties will have access to the site by appointment. All parties will be accompanied when first entering the property.

5. Current and future assets to support the plan

All fundamental aspects of the farm enterprise have been developed and currently exist except for the availability of a residential dwelling which is necessary for the successful operation of the business and farm management plan.

Current assets include:

- Extensive stable block with 4 horse boxes
- A large feed and tack room,
- Horse wash and preparation area.
- 6 small horse paddocks plus 3 larger paddocks, all with horse shelters and piped water troughs.
- · All existing fencing around the horse paddocks is electrified

· All cladding is non reflective

An exercise and training arena exists on the property which will support horse training and rider instruction and support breaking in and re-education programs. This facility will be used for the daily exercise of horses as well as.

Future assets

- The dwelling will incorporate a meeting room and staff accommodation when the owners are absent
- We will construct a vet crush for the treatment of the horses.

Please refer to photographs m Appendix A to see scope of current facilities and site layout.

Future development

- 1. Paddock Improvement
 - A fertilizer program will be implemented to ensure a greater quality of feed.
 - Paddocks will be rotated and used in conjunction with the stables and round yard giving the paddocks a rest when needed.
 - c. The existing paddock size and locations onsite including stable location are in line with our plans going forward. We will make no changes to the current layout of the paddocks except to improve paddocks close to the house for foaling down and care of foals.

2. Trees


a. Existing trees will stay in place to provide shelter along south boundary. Trees will be planted along the west boundary to provide security from adjacent farming operations.


3. Dams

 Current dams provide sufficient water, and there is scope to increase the size of the smaller dams if required.

4. Parking

- a. A gravel area for onsite parking for cars and horse floats already exists and there is scope to enlarge this if required over time.
- 5. Further improvements as the business expands will include
 - a. Creation of additional small paddocks for short stay animals
 - b. Develop safe yard for foaling down and care of foals
 - c. Foaling paddock close to the house
 - d. Vegetation improvement to facilitate a larger stocking rate and for erosion control, which is a valuable contribution to the area.

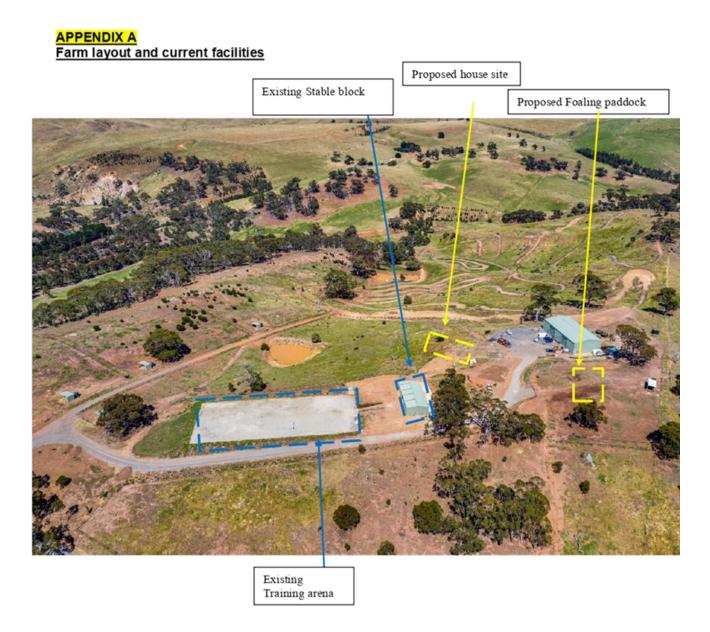

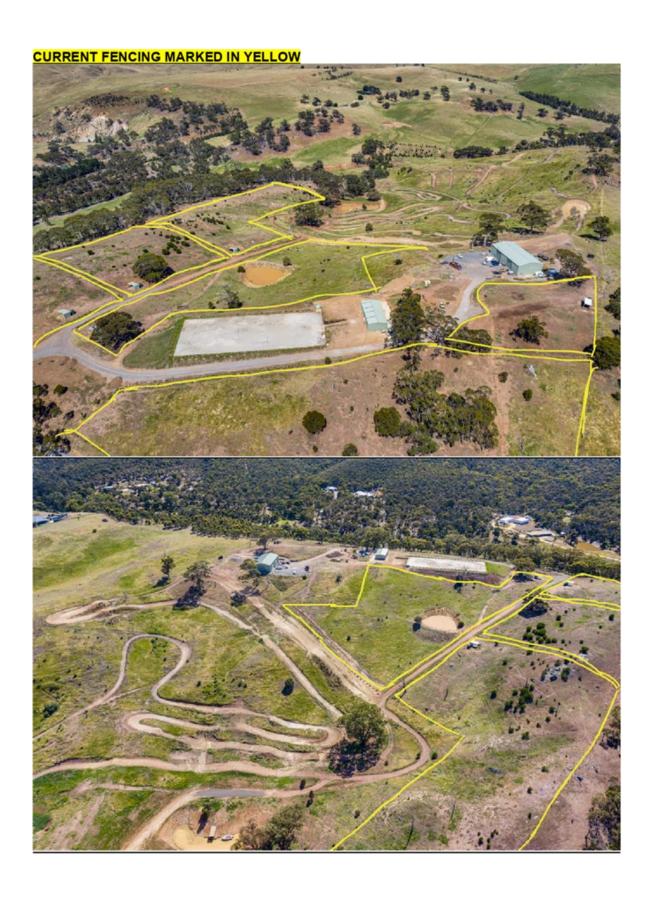






Page 23 Item 7.2 - Attachment 2

THIS SET OF DRAWINGS IS TO BE READ IN CONJUNCTION WITH THE FOLLOWING:

- 1. The certificate of title and Plan of Subdivision as noted below right
- 2. Copy of "Moorabool Shire Council" planning response letter dated 15-09-2021

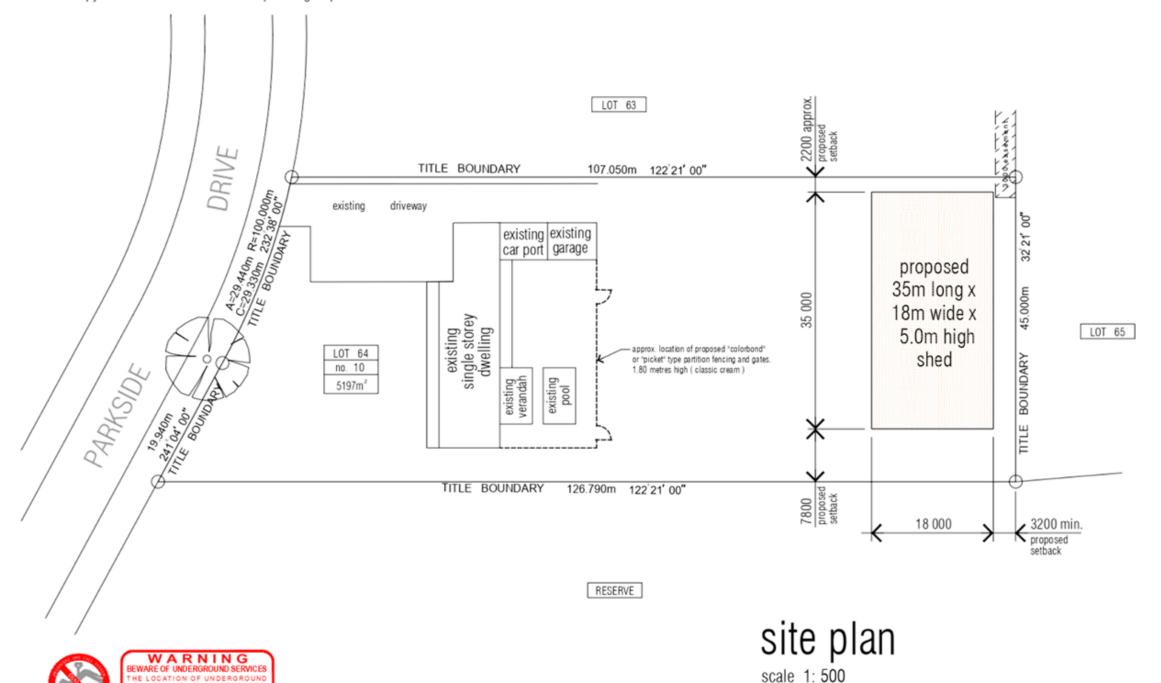

 Site Information

 Zoning
 Low Density Residential Zone (LDRZ)

 Lot Area
 5197m²

 Water Authority 1
 Southern Rural Water

 Water Authority 2
 Western Water

 Municipality
 Moorabool

 Council Property No.
 445116

 Plan of Subdivision
 PS 518686 Y

 Melway Reference
 Map 341 C / 2

 Parish
 Merrimu

 design criteria

 Site Soil Classification

 Wind Rating

 Bushfire Attack Level

 Energy Rating
 N/A

 Alpine Area
 No

 Termite Area
 Flood Prone Area

 Designated Land or Works
 Reticulated

these drawings are to be read in conjunction with the certificate of title

volume : 10819 folio : 719

plan of subdivision PS 518686 Y

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Output

KOTES :

. This drawing shall be read in conjunction with all other drawings in the set for this development and all other relevant drawings, specifications, sketches, computations etc. including those by others. All confractors are to verify all dimensions on alle prior to commencing any work or shop detailing or ordering any materials.

 The Droftsperson / Engineer shall be notified if there are any discrepancies prior to commencing.
 All materials and workmanship shall conform to the relevant current

ely/STATus	DISCREPTION	DATE
	ISSUED FOR PLANNING INFORMATION	21-03-2022
8	HEIGHT REVISED DOWN TO 5.0m	04-05-2022
		+
		_
		_
		_

Registered Building Practitioner Architectural - divil - structural design draftsperson

> peration N° DP-AD22036 peration N° DP-8D67 mobile (0407-531-125 office (53-67-5616 at () mh75616 associat





FERMUNRY 2022

proposed shed 35m long x 18m wide x 5.0m high

(lot 64) no. 10 parkside drive, hopetoun park, victoria, 3340

Paul Austin & Katerina Charalambou

ONAMENTAL STATUS:


TOWN PLANNING

not for construction

ONA ROLL

24 507 TD02 4 P.

Item 7.3 - Attachment 1

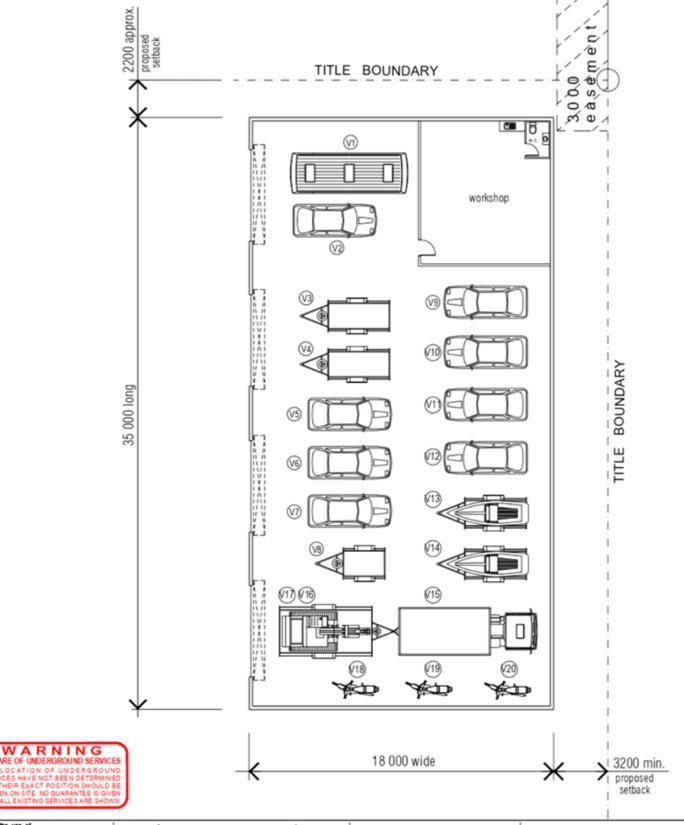

Schedule of motor vehicles to be stored

- (V1) Motor home
- V2 Work Car
- Tandem Trailer
- Tandem Trailer
- Hobby Car
- (V6) Family Car
- (V7) Family Car
- (V8) Box Trailer
- V9 Hobby Car
- (/10) Hobby Car
- (V11) Hobby Car
- V12 Hobby Car
- V13 Boat
- V14 Boat
- (V15) Tandem Truck
- (V16) Excavator
- (17) Float Trailer
- (18) Motor Bike
- (V19) Motor Bike
- (V20) Motor Bike

floor plan scale 1: 200

these drawings are to be read in conjunction with the certificate of title

volume: 10819 folio: 719

plan of subdivision PS 518686 Y

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21-03-2022 04-05-2022 ISSUED FOR PLANNING INFORMATION

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floor plan **TOWN PLANNING**

